

STANDARD AND SPECIFICATIONS FOR
TEMPORARY CONSTRUCTION AREA SEEDING



Criteria

Water management practices must be installed as appropriate for site conditions. The area must be rough graded and slopes physically stable. Large debris and rocks are usually removed. Seedbed must be seeded within 24 hours of disturbance or scarification of the soil surface will be necessary prior to seeding.

Fertilizer or lime are not typically used for temporary seedings.

IF: Spring or summer or early fall, then seed the area with ryegrass (annual or perennial) at 30 lbs. per acre (Approximately 0.7 lb./1000 sq. ft. or use 1 lb./1000 sq. ft.).

IF: Late fall or early winter, then seed Certified 'Aroostook' winter rye (cereal rye) at 100 lbs. per acre (2.5 lbs./1000 sq. ft.).

Any seeding method may be used that will provide uniform application of seed to the area and result in relatively good soil to seed contact.

Mulch the area with hay or straw at 2 tons/acre (approx. 90 lbs./1000 sq. ft. or 2 bales). Quality of hay or straw mulch allowable will be determined based on long term use and visual concerns. Mulch anchoring will be required where wind or areas of concentrated water are of concern. Wood fiber hydromulch or other sprayable products approved for erosion control (nylon web or mesh) may be used if applied according to manufacturers' specification. **Caution** is advised when using nylon or other synthetic products. They may be difficult to remove prior to final seeding and can be a hazard to young wildlife species.

Definition & Scope

Providing temporary erosion control protection to disturbed areas and/or localized critical areas for an interim period by covering all bare ground that exists as a result of construction activities or a natural event. Critical areas may include but are not limited to steep excavated cut or fill slopes and any disturbed, denuded natural slopes subject to erosion.

Conditions Where Practice Applies

Temporary seedings may be necessary on construction sites to protect an area, or section, where final grading is complete, when preparing for winter work shutdown, or to provide cover when permanent seedings are likely to fail due to mid-summer heat and drought. The intent is to provide temporary protective cover during temporary shutdown of construction and/or while waiting for optimal planting time.

STANDARD AND SPECIFICATIONS FOR
TOPSOILING



Definition & Scope

Spreading a specified quality and quantity of topsoil materials on graded or constructed subsoil areas to provide acceptable plant cover growing conditions, thereby reducing erosion; to reduce irrigation water needs; and to reduce the need for nitrogen fertilizer application.

Conditions Where Practice Applies

Topsoil is applied to subsoils that are droughty (low available moisture for plants), stony, slowly permeable, salty or extremely acid. It is also used to backfill around shrub and tree transplants. This standard does not apply to wetland soils.

Design Criteria

1. Preserve existing topsoil in place where possible, thereby reducing the need for added topsoil.
2. Conserve by stockpiling topsoil and friable fine textured subsoils that must be stripped from the excavated site and applied after final grading where vegetation will be established. Topsoil stockpiles must be stabilized. Stockpile surfaces can be stabilized by vegetation, geotextile or plastic covers. This can be aided by orientating the stockpile lengthwise into prevailing winds.
3. Refer to USDA Natural Resource Conservation Service soil surveys or soil interpretation record sheets for further soil texture information for selecting appropriate design topsoil depths.

Site Preparation

1. As needed, install erosion and sediment control practices such as diversions, channels, sediment traps, and stabilizing measures, or maintain if already installed.
2. Complete rough grading and final grade, allowing for depth of topsoil to be added.
3. Scarify all compact, slowly permeable, medium and fine textured subsoil areas. Scarify at approximately right angles to the slope direction in soil areas that are steeper than 5 percent. Areas that have been overly compacted shall be decompacted in accordance with the Soil Restoration Standard.
4. Remove refuse, woody plant parts, stones over 3 inches in diameter, and other litter.

Topsoil Materials

1. Topsoil shall have at least 6 percent by weight of fine textured stable organic material, and no greater than 20 percent. Muck soil shall not be considered topsoil.
2. Topsoil shall have not less than 20 percent fine textured material (passing the NO. 200 sieve) and not more than 15 percent clay.
3. Topsoil treated with soil sterilants or herbicides shall be so identified to the purchaser.
4. Topsoil shall be relatively free of stones over 1 1/2 inches in diameter, trash, noxious weeds such as nut sedge and quackgrass, and will have less than 10 percent gravel.
5. Topsoil containing soluble salts greater than 500 parts per million shall not be used.
6. Topsoil may be manufactured as a mixture of a mineral component and organic material such as compost.

Application and Grading

1. Topsoil shall be distributed to a uniform depth over the area. It shall not be placed when it is partly frozen, muddy, or on frozen slopes or over ice, snow, or standing water puddles.
2. Topsoil placed and graded on slopes steeper than 5 percent shall be promptly fertilized, seeded, mulched, and stabilized by "tracking" with suitable equipment.
3. Apply topsoil in the amounts shown in Table 4.7 below:

Table 4.7 - Topsoil Application Depth		
Site Conditions	Intended Use	Minimum Topsoil Depth
1. Deep sand or loamy sand	Mowed lawn	6 in.
	Tall legumes, unmowed	2 in.
	Tall grass, unmowed	1 in.
2. Deep sandy loam	Mowed lawn	5 in.
	Tall legumes, unmowed	2 in.
	Tall grass, unmowed	none
3. Six inches or more: silt loam, clay loam, loam, or silt	Mowed lawn	4 in.
	Tall legumes, unmowed	1 in.
	Tall grass, unmowed	1 in.

Decompaction


At the end of the project an inspector should be able to push a 3/8" metal bar 12 inches into the soil just with body weight. This should not be performed within the drip line of any existing trees or over utility installations that are within 24 inches of the surface.

Maintenance

Keep the site free of vehicular and foot traffic or other weight loads. Consider pedestrian footpaths.

Table 4.6
AG & Markets Soil Restoration Requirements

Type of Soil Disturbance	Soil Restoration Requirement		Comments/Examples
No soil disturbance	Restoration not permitted		Preservation of Natural Features
Minimal soil disturbance	Restoration not required		Clearing and grubbing
Areas where topsoil is stripped only - no change in grade	HSG A&B	HSG C&D	Protect area from any ongoing construction activities.
	Apply 6 inches of topsoil	Aerate* and apply 6 inches of topsoil	
Areas of cut or fill	HSG A&B	HSG C&D	Apply full Soil Restoration**
	Aerate* and apply 6 inches of topsoil	Apply full Soil Restoration**	
Heavy traffic areas on site (especially in a zone 5-25 feet around buildings but not within a 5 foot perimeter around foundation walls)	Apply full Soil Restoration (decompaction and compost enhancement)		
Areas where Runoff Reduction and/or Infiltration practices are applied	Restoration not required, but may be applied to enhance the reduction specified for appropriate practices.		Keep construction equipment from crossing these areas. To protect newly installed practice from any ongoing construction activities construct a single phase operation fence area
Redevelopment projects	Soil Restoration is required on redevelopment projects in areas where existing impervious area will be converted to pervious area.		
* Aeration includes the use of machines such as tractor-drawn implements with coulters making a narrow slit in the soil, a roller with many spikes making indentations in the soil, or prongs which function like a mini-subsoiler. ** Per "Deep Ripping and De-compaction, DEC 2008".			

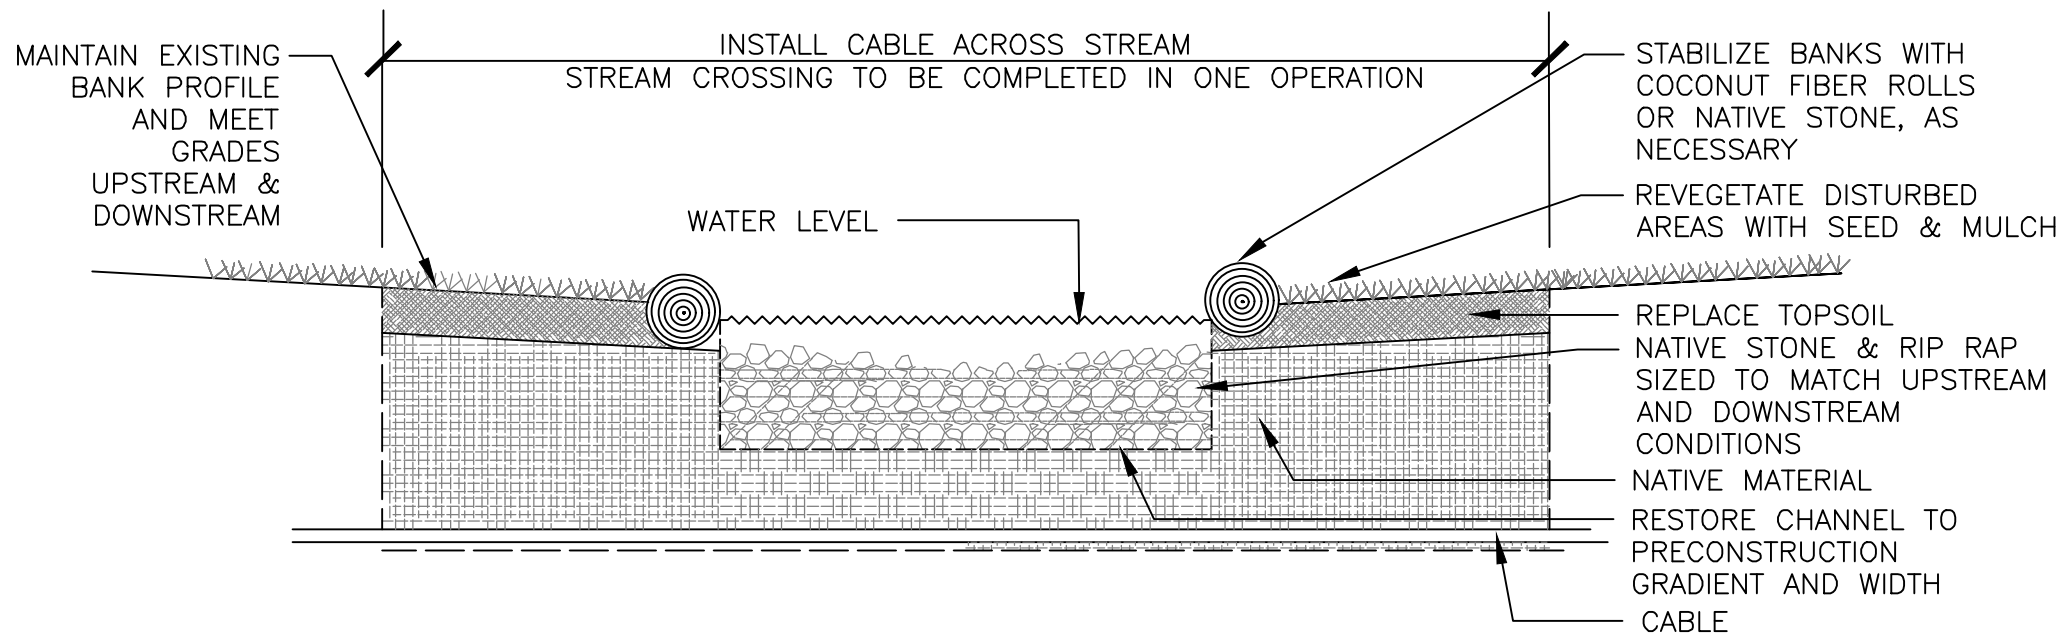


NOTES:

1. THE RESTORED STREAM CHANNEL SHALL BE EQUAL IN WIDTH, DEPTH, GRADIENT, LENGTH AND CHARACTER AS THE PRE-EXISTING STREAM CHANNEL AND TIE IN SMOOTHLY TO PROFILE OF THE STREAM CHANNEL UPSTREAM AND DOWNSTREAM OF THE PROJECT AREA. THE PLANTFORM OF AND STREAM NOT BE CHANGED.
2. ANY IN-STREAM WORK OR RESTORATION SHALL NOT RESULT IN AN IMPEDIMENT TO PASSAGE OF AQUATIC ORGANISM.
3. ANY IN-STREAM WORK (EXCLUDING DEWATERING PRACTICES ASSOCIATED WITH DRY TRENCH CROSSINGS) AND RESTORATION SHALL BE CONSTRUCTED IN A MANNER WHICH MAINTAINS LOW FLOW CONDITIONS AND PRESERVES WATER DEPTHS AND VELOCITIES SIMILAR TO UNDISTURBED UPSTREAM AND DOWNSTREAM REACHES NECESSARY TO SUSTAIN THE MOVEMENT OF NATIVE AQUATIC ORGANISMS. ANY IN-STREAM HABITAT STRUCTURES SHALL NOT CREATE A DROP HEIGHT GREATER THAN SIX INCHES.
4. ALL DISTURBED STREAM BANKS BELOW THE NORMAL HIGH-WATER ELEVATION MUST BE GRADED NO STEEPER THAN ONE VERTICAL TO TWO HORIZONTAL SLOPE (1:2), OR TO THE ORIGINAL GRADE AS APPROPRIATE, AND ADEQUATELY STABILIZED.
5. ALL OTHER AREAS OF SOIL DISTURBANCE ABOVE THE ORDINARY HIGH-WATER ELEVATION, OR ELSEWHERE, SHALL BE STABILIZED WITH NATURAL FIBER MATTING, SEEDED WITH AND APPROPRIATE PERENNIAL NATIVE CONSERVATION SEED MIX, AND MULCHED WITH STRAW WITHIN TWO (2) DAYS OF FINAL GRADING. MULCH SHALL BE MAINTAINED UNTIL SUITABLE VEGETATION COVER IS ESTABLISHED.
6. DESTROYED BANK VEGETATION SHALL BE REPLACED WITH APPROPRIATE NATIVE SHRUBS, LIVE STAKES, AND/OR TREE PLANTINGS AS SITE CONDITIONS, AS APPROPRIATE.

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STREAM RESTORATION DETAIL
N.T.S.

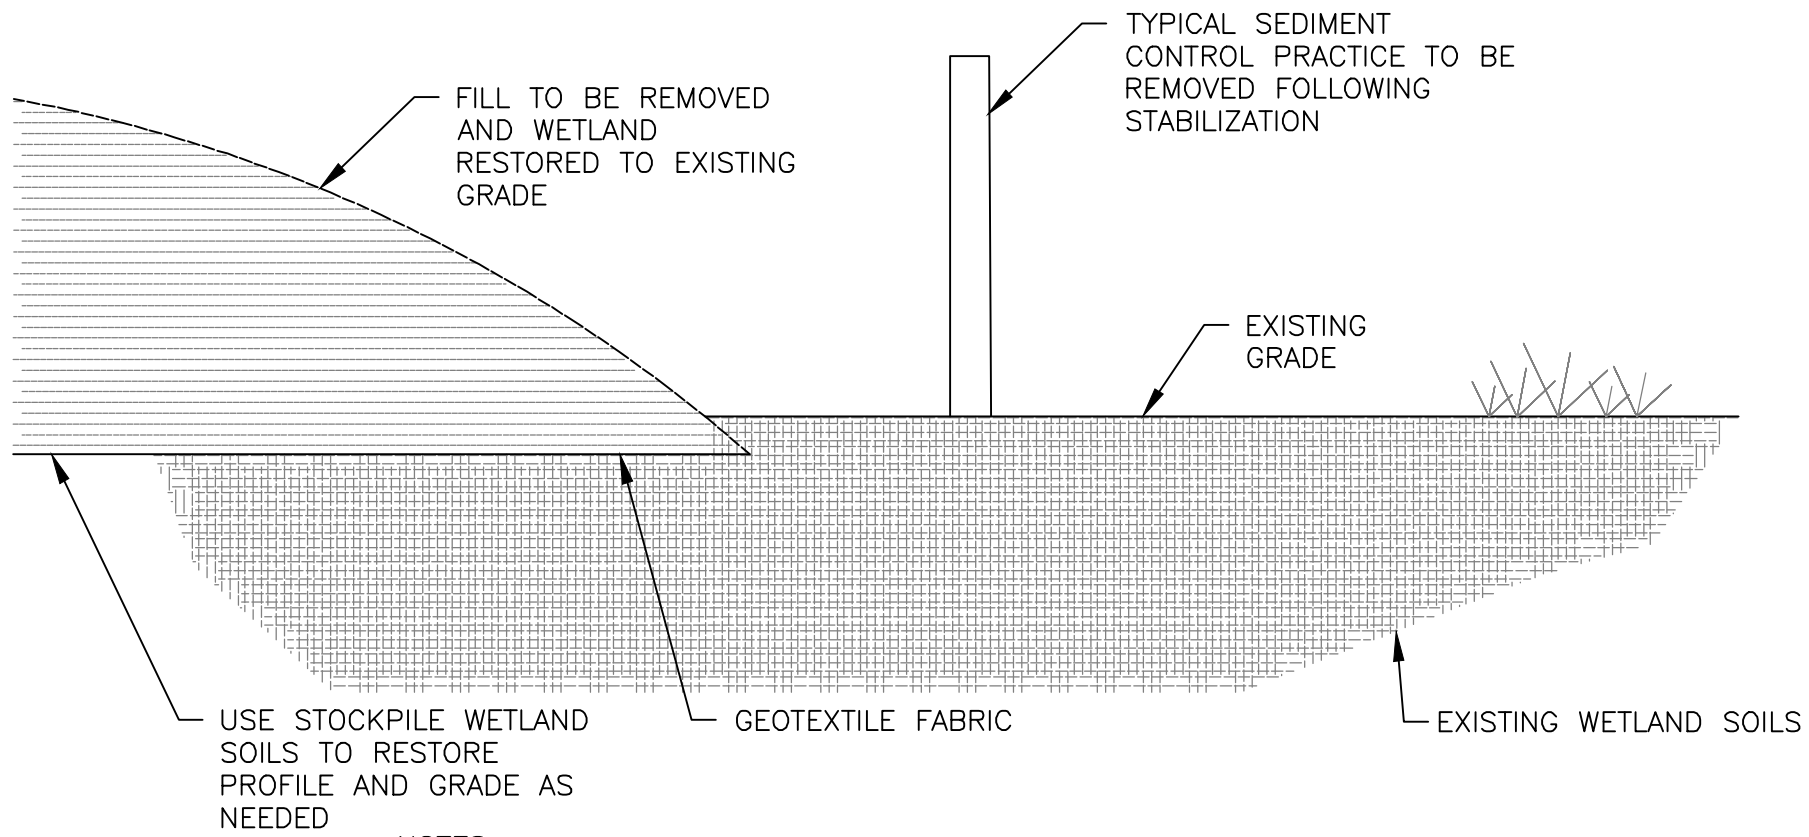

NOTES:

1. ALL FILL TO BE REMOVED FROM WETLAND
2. ALL FILL MATERIAL TO BE DISCHARGED TO A LEGAL UPLAND LOCATION.
3. STABILIZE AREA IN ACCORDANCE WITH SWPPP.
4. LIMIT WORK TO TEMPORARY DISTURBED AREAS AS SHOWN ON PERMIT DRAWING.
5. CONTOURS SHALL BE RESTORED TO PRE-CONSTRUCTION CONDITIONS WITHIN 48 HOURS OF FINAL BACKFILLING OF THE TRENCH WITHIN WETLANDS AND STATE-REGULATED ADJACENT AREAS.
6. IMMEDIATELY UPON COMPLETION OF GRADING, WETLAND AND ADJACENT AREAS SHALL BE SEEDED AND/OR REPLANTED WITH NATIVE SHRUBS AND HERBACEOUS PLANTS AT PRE-CONSTRUCTION DENSITIES. SEEDING WITH AND APPROPRIATE NATIVE WETLAND SPECIES MIX (E.G. ERNST WETLAND MIX, OBL-FACW PERENNIAL WETLAND MIX, (OBL WETLAND MIX, SPECIALIZED WETLAND MIX FOR SHADED OBL-FACW), OR EQUIVALENT) SHALL BE COMPLETED TO HELP STABILIZE THE SOILS.
7. WETLAND RESTORATION AREAS SHALL BE MONITORED FOR A MINIMUM OF 5 YEARS OR UNTIL AN 80% COVER OF PLANTS WITH THE APPROPRIATE WETLAND INDICATOR STATUS HAS BEEN REESTABLISHED OVER ALL PORTIONS OF THE RESTORED AREA. AT THE END OF THE FIRST YEAR OF MONITORING, THE CERTIFICATE HOLDER SHALL REPLACE LOST WETLAND AND/OR WETLAND ADJACENT AREA PLANTINGS IF THE SURVIVAL RATE OF THE INITIAL PLANTINGS IS LESS THAN 80%; AND
8. IF AT THE END OF THE SECOND YEAR OF MONITORING, THE CRITERIA FOR RESTORATION PLANTINGS (80% COVER, 80% SURVIVAL OF PLANTINGS) ARE NOT MET, THEN THE CERTIFICATE HOLDER MUST ESCALATE THE REASONS FOR THESE RESULTS AND SUBMIT AN APPROVABLE WETLAND PLANTING REMEDIAL PLAN (WPRP) FOR DEC AND DPS APPROVAL. THE WPRP MUST INCLUDE THE FOLLOWING:
A) ANALYSIS OF POOR SURVIVAL;
B) CORRECTIVE ACTIONS TO ENSURE A SUCCESSFUL RESTORATION; AND
C) SCHEDULE FOR CONDUCTING THE REMEDIAL WORK. ONCE APPROVED, THE WPRP WILL BE IMPLEMENTED ACCORDING TO THE APPROVED SCHEDULE.

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WETLAND RESTORATION DETAIL
N.T.S.

CONCEPTUAL - NOT FOR CONSTRUCTION

C	07/14/2021	JSD	ISSUED FOR 94C	KW	NJM
B	05/21/2021	RCB	ISSUED FOR REVIEW	KW	NJM
A	01/29/2021	RCB	ISSUED FOR REVIEW	KW	NJM
Rev	Date	Drawn	Description	Ch'k'd	App'd

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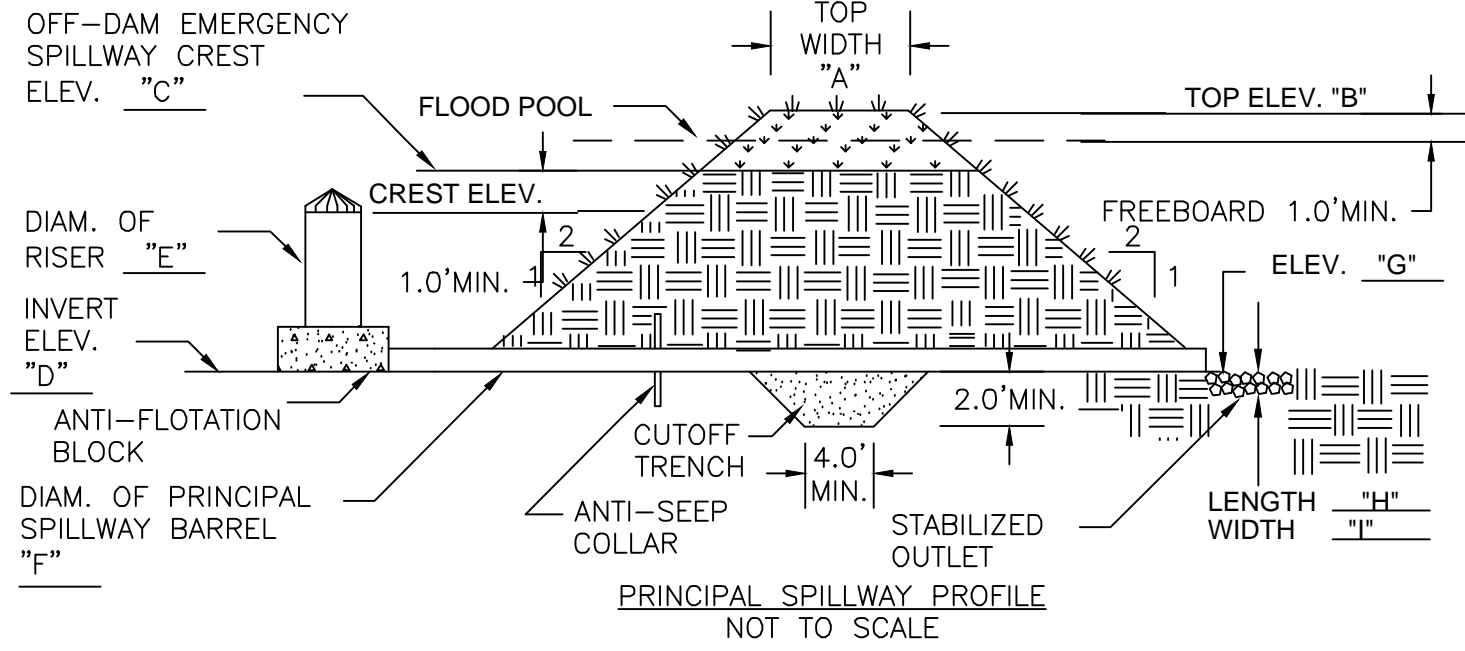


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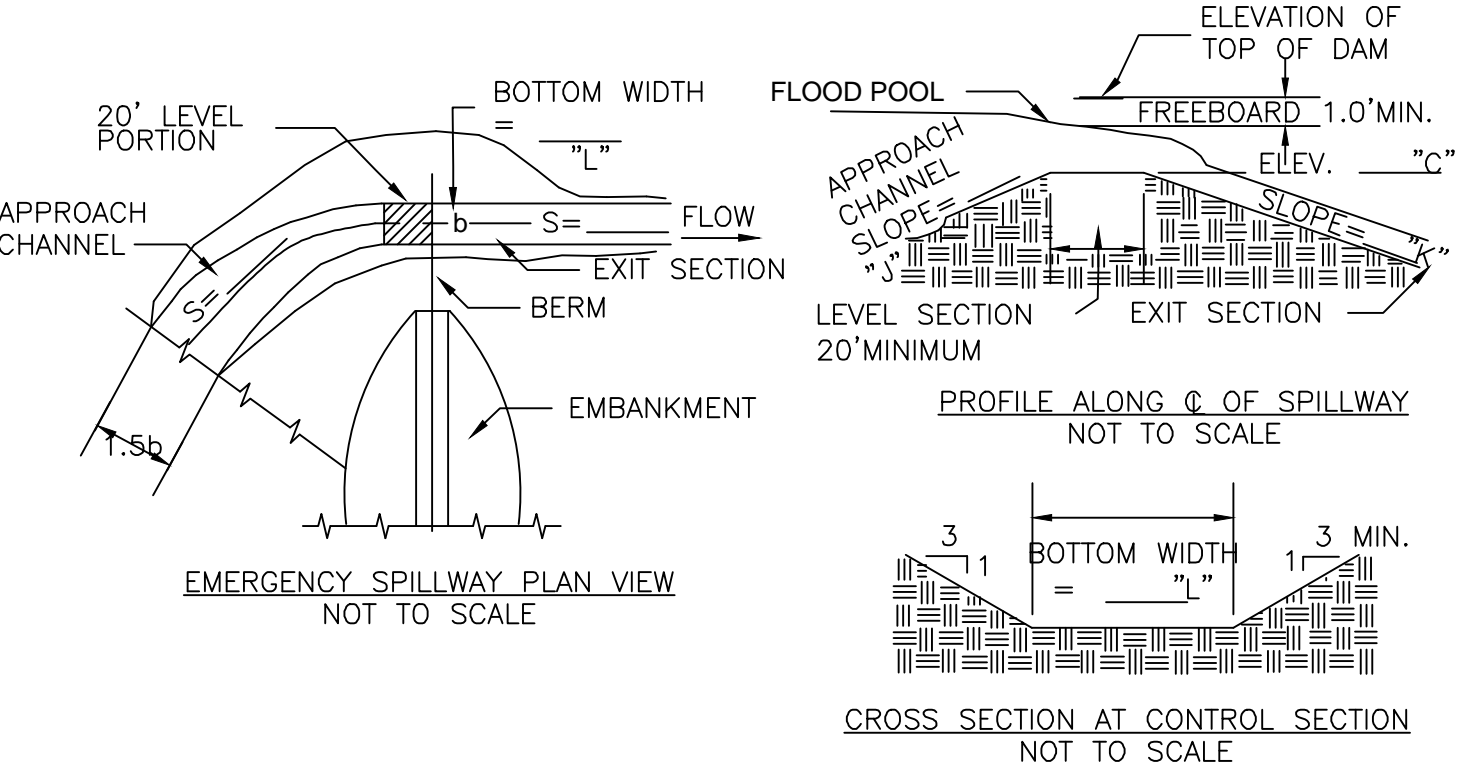
SOUTH RIPLEY SOLAR
TYPICAL CIVIL DETAILS
SHEET 8 OF 10

PRELIMINARY
NOT FOR
CONSTRUCTION
REPLACE WITH
ENGINEERS STAMP
AT CONSTRUCTION
AND/OR FABRICATION

Designed	MU	Eng check	KW
Drawn	RCB	Approved	NJM
Scale at ANSI D NTS		Date 07/14/2021	Rev C
Drawing Number SRS-C-101-08			




MAXIMUM DRAINAGE AREA = 50 ACRES




CONSTRUCTION SPECIFICATIONS

- AREAS UNDER THE EMBANKMENT SHALL BE CLEARED, GRUBBED, AND STRIPPED OF TOPSOIL TO REMOVE TREES, VEGETATION, ROOTS, OR OTHER OBJECTIONABLE MATERIAL. IN ORDER TO FACILITATE CLEANOUT AND RESTORATION, THE POOL AREA (MEASURED AT THE TOP OF THE PIPE SPILLWAY) WILL BE CLEARED OF ALL BRUSH, TREES, AND OTHER OBJECTIONABLE MATERIALS.
- A CUTOFF TRENCH SHALL BE EXCAVATED ALONG THE CENTERLINE OF EARTH FILL EMBANKMENTS. THE MINIMUM DEPTH SHALL BE TWO FEET. THE CUTOFF TRENCH SHALL EXTEND UP BOTH ABUTMENTS TO THE RISER CREST ELEVATION. THE MINIMUM BOTTOM WIDTH SHALL BE FOUR FEET, BUT WIDE ENOUGH TO PERMIT OPERATION OF EXCAVATION AND COMPACTION EQUIPMENT. THE SIDE SLOPES SHALL BE NO STEEPER THAN 1:1. COMPACTION REQUIREMENTS SHALL BE THE SAME AS THOSE FOR EMBANKMENT. THE TRENCH SHALL BE DE-WATERED DURING THE BACK-FILLING/COMPACTION OPERATIONS.
- THE FILL MATERIAL SHALL BE TAKEN FROM APPROVED AREAS SHOWN ON THE PLANS. IT SHALL BE CLEAN MINERAL SOIL FREE OF ROOTS, WOODED VEGETATION, OVERSIZED STONES, ROCKS, OR OTHER OBJECTIONABLE MATERIAL. RELATIVELY PERVIOUS MATERIAL SUCH AS SNAG OR GRAVEL (UNIFIED SOIL CLASSES GW, GP, SW & SP) SHALL NOT BE PLACED IN THE EMBANKMENT. AREAS ON WHICH FILL IS TO BE PLACED SHALL BE SCARIFIED PRIOR TO PLACEMENT OF FILL. THE FILL MATERIAL SHALL CONTAIN SUFFICIENT MOISTURE SO THAT IT CAN BE FORMED BY HAND INTO A BALL WITHOUT CRUMBING. IF WATER CAN BE SQUEEZED OUT OF A BALL, IT IS TOO WET FOR PROPER COMPACTION. FILL MATERIAL SHALL BE PLACED IN SIX TO EIGHT INCH THICK CONTINUOUS LAYERS OVER THE ENTIRE LENGTH OF THE FILL. COMPACTION SHALL BE OBTAINED BY ROUTING AND HAULING THE CONSTRUCTION EQUIPMENT OVER THE FILL. SO THAT THE ENTIRE SURFACE OF EACH LAYER OF THE FILL IS TRAVERSED BY AT LEAST ONE WHEEL OR TREAD TRACK OF THE EQUIPMENT OR BY THE USE OF A COMPACTOR. THE EMBANKMENT SHALL BE CONSTRUCTED TO AN ELEVATION 10 PERCENT HIGHER THAN THE DESIGN HEIGHT TO ALLOW FOR SETTLEMENT.
- THE RISER SHALL BE SECURELY ATTACHED TO THE BARREL OR BARREL STUB BY WELDING THE FULL CIRCUMFERENCE MAKING A WATERTIGHT STRUCTURAL CONNECTION. THE BARREL STUB MUST BE ATTACHED TO THE RISER AT THE SAME PERCENT (ANGLE) OF GRADE AS THE OUTLET CONDUIT. THE CONNECTION BETWEEN THE RISER AND THE RISER BASE SHALL BE WATERTIGHT. ALL CONNECTIONS BETWEEN BARREL SECTIONS MUST BE ACHIEVED BY APPROVED WATERTIGHT BANK ASSEMBLIES. THE BARREL AND RISER SHALL BE PLACED ON A FIRM, SMOOTH FOUNDATION OF IMPERVIOUS SOIL. PERVIOUS MATERIALS SUCH AS SAND, GRAVEL, OR CRUSHED STONE SHALL NOT BE USED AS BACKFILL AROUND THE PIPE OR ANTI-SEEP COLLARS. THE FILL MATERIAL AROUND THE PIPE SPILLWAY SHALL BE PLACED IN FOUR-INCH LAYERS AND COMPACTED UNDER AND AROUND THE PIPE TO AT LEAST THE SAME DENSITY AS THE ADJACENT EMBANKMENT.
- A MINIMUM DEPTH OF TWO FEET OF HAND COMPACTED BACKFILL SHALL BE PLACED OVER THE PIPE SPILLWAY BEFORE CROSSING IT WITH CONSTRUCTION EQUIPMENT. STEEL BASE PLATES ON RISERS SHALL HAVE AT LEAST 2 1/2 FEET OF COMPACTED EARTH, STONE, OR GRAVEL PLACED OVER IT TO PREVENT FLOTATION.
- THE EMERGENCY SPILLWAY SHALL BE INSTALLED IN UNDISTURBED GROUND. THE ACHIEVEMENT OF PLANNED ELEVATIONS, GRADES, DESIGN WIDTH, ENTRANCE AND EXIT CHANNEL SLOPES ARE CRITICAL TO THE SUCCESSFUL OPERATION OF THE EMERGENCY SPILLWAY AND MUST BE CONSTRUCTED WITHIN A TOLERANCE OF +/- 0.2 FEET.
- STABILIZE THE EMBANKMENT AND EMERGENCY SPILLWAY IN ACCORDANCE WITH THE APPROPRIATE VEGETATIVE STANDARD AND SPECIFICATION IMMEDIATELY FOLLOWING CONSTRUCTION. IN NO CASE SHALL THE EMBANKMENT REMAIN UNSTABILIZED FOR MORE THAN THREE (3) DAYS.
- CONSTRUCTION OPERATIONS SHALL BE CARRIED OUT IN SUCH A MANNER THAT EROSION AND WATER POLLUTION WILL BE MINIMIZED. STATE AND LOCAL LAWS SHALL BE COMPLIED WITH CONCERNING POLLUTION ABATEMENT.
- STATE AND LOCAL REQUIREMENTS SHALL BE MET CONCERNING FENCING AND SIGNS, WARNING THE PUBLIC OF HAZARDS OF SOFT SEDIMENT AND FLOODWATER.
- REPAIR ALL DAMAGES CAUSED BY SOIL EROSION AND CONSTRUCTION EQUIPMENT AT OR BEFORE THE END OF EACH WORKING DAY.
- SEDIMENT SHALL BE REMOVED FROM THE BASIN WHEN IT REACHES THE SPECIFIED DEPTH FOR CLEANOUT NOTED ON THE PLANS WHICH WILL NOT EXCEED 50% OF THE CAPACITY OF THE SEDIMENT STORAGE ZONE. THIS SEDIMENT SHALL BE PLACED IN SUCH A MANNER THAT IT WILL NOT ERODE FROM THE SITE. THE SEDIMENT SHALL NOT BE DEPOSITED DOWNSTREAM FROM THE EMBANKMENT, ADJACENT TO A STREAM OR FLOODPLAIN.
- WHEN TEMPORARY STRUCTURES HAVE SERVED THEIR INTENDED PURPOSE AND THE CONTRIBUTING DRAINAGE AREA HAS BEEN PROPERLY STABILIZED, THE EMBANKMENT AND RESULTING SEDIMENT DEPOSITS ARE TO BE LEVELED OR OTHERWISE DISPOSED OF IN ACCORDANCE WITH THE APPROVED SEDIMENT CONTROL PLAN. THE PROPOSED USE OF A SEDIMENT BASIN SITE WILL OFTEN DICTATE FINAL DISPOSITION OF THE BASIN AND ANY SEDIMENT CONTAINED THEREIN. IF THE SITE IS SCHEDULED FOR FUTURE CONSTRUCTION, THEN THE BASIN MATERIAL AND TRAPPED SEDIMENTS MUST BE REMOVED, SAFELY DISPOSED OF, AND BACKFILLED WITH A STRUCTURAL FILL. WHEN THE BASIN AREA IS TO REMAIN OPEN SPACE, THE POND MAY BE PUMPED DRY, GRADED, AND BACKFILLED.

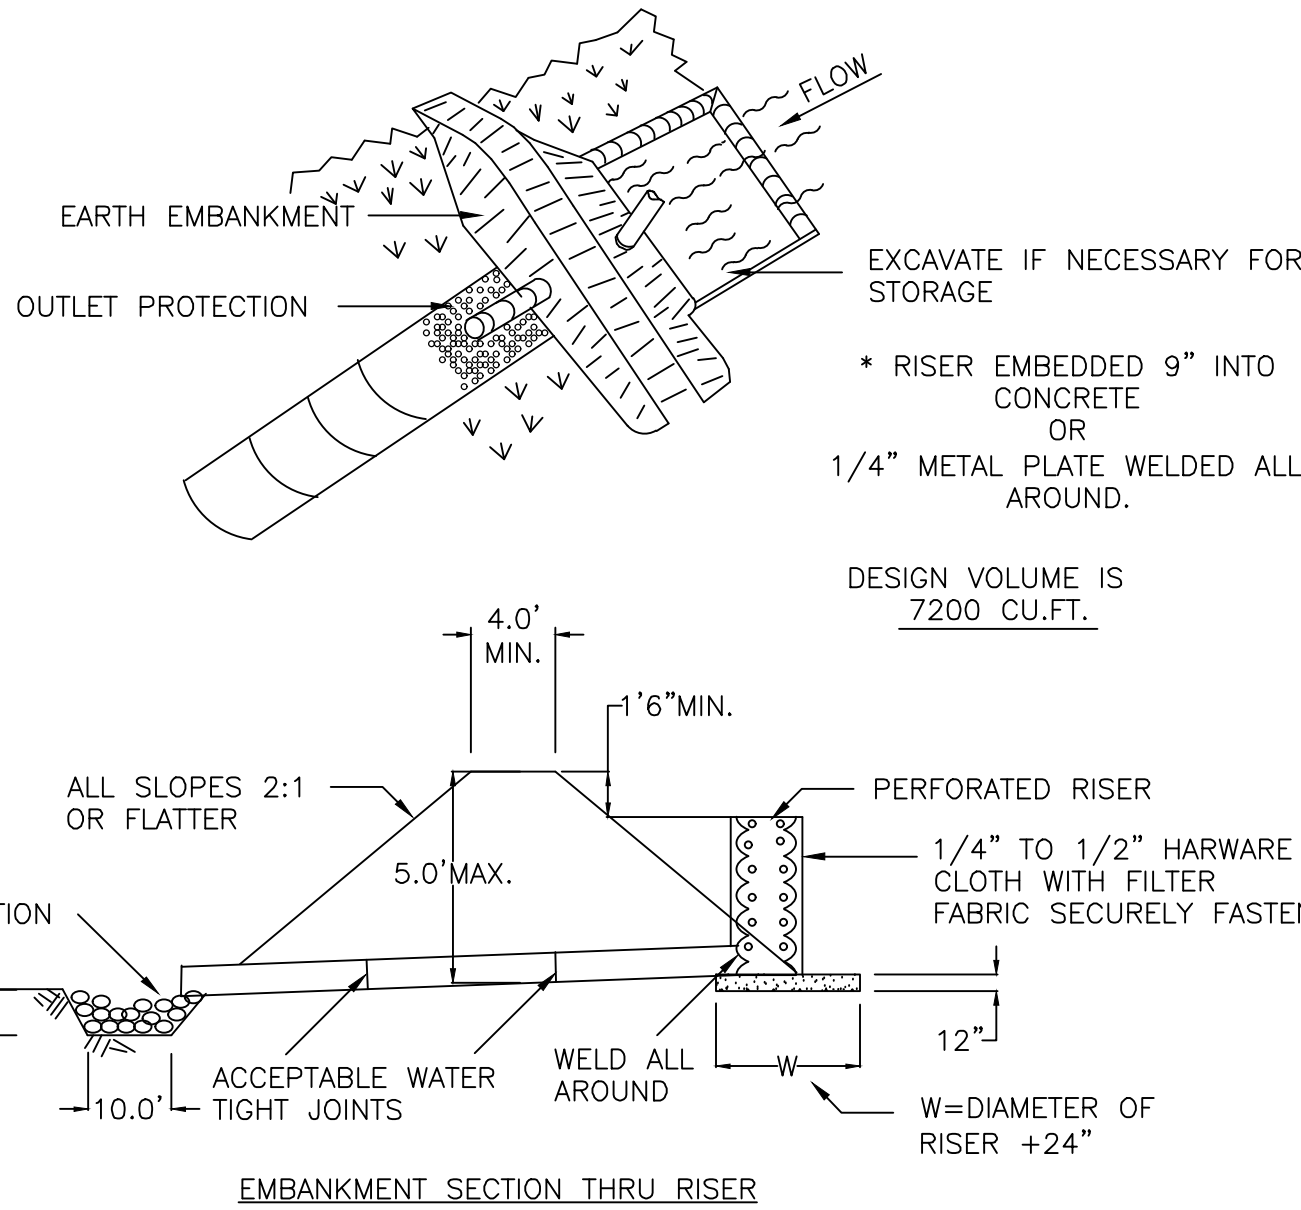

SIZES OF PIPE NEEDED (PIPE OUTLET SEDIMENT TRAP 1):
BARREL DIAMETER: 18"
RISER DIAMETER: 21"

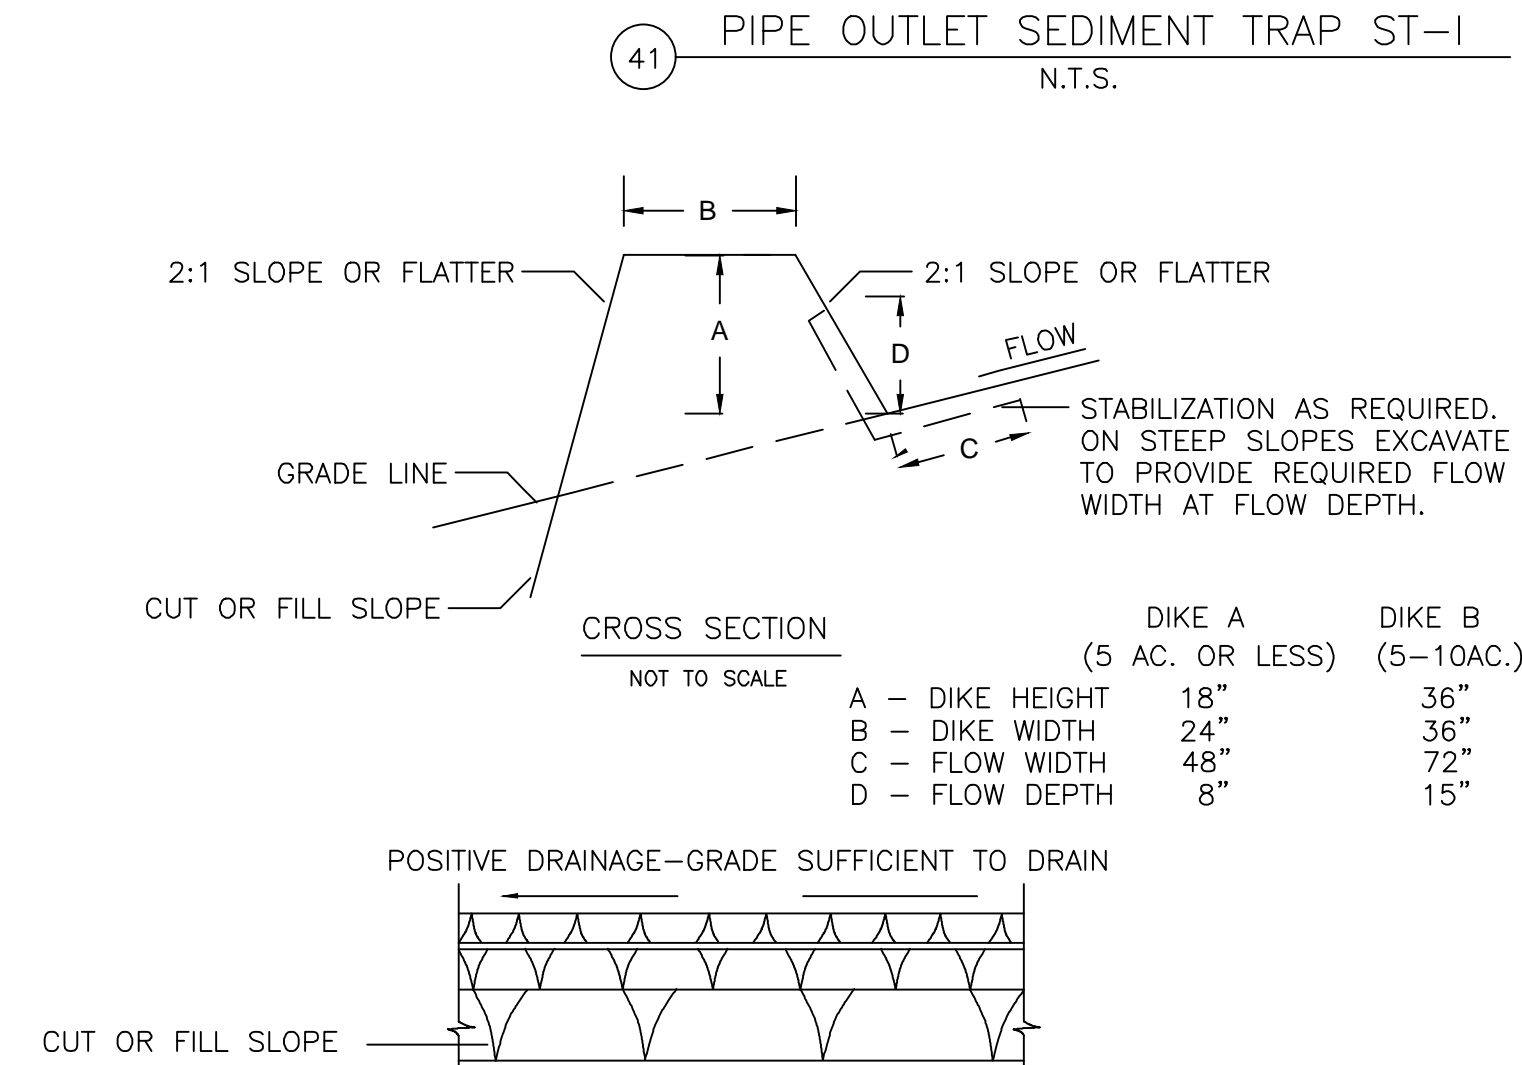


CONSTRUCTION SPECIFICATIONS

- ALL DIKES SHALL BE COMPACTED BY EARTH-MOVING EQUIPMENT.
- ALL DIKES SHALL HAVE POSITIVE DRAINAGE TO AN OUTLET.
- TOP WIDTH MAY BE WIDER AND SIDE SLOPES BE FLATTER IF DESIRED TO FACILITATE CROSSING BY CONSTRUCTION TRAFFIC.
- FIELD LOCATION SHOULD BE ADJUSTED AS NEEDED TO UTILIZE A STABILIZED SAFE OUTLET.
- EARTH DIKES SHALL HAVE AN OUTLET THAT FUNCTIONS WITH A MINIMUM OF EROSION. RUNOFF SHALL BE CONVEYED TO A SEDIMENT TRAPPING DEVICE SUCH AS A SEDIMENT TRAP OR SEDIMENT BASIN WHERE EITHER THE DIKE CHANNEL OR THE DRAINAGE AREA ABOVE THE DIKE ARE NOT ADEQUATELY STABILIZED.
- FILL STABILIZATION SHALL BE: (A) IN ACCORDANCE WITH STANDARD SPECIFICATIONS FOR SEED AND STRAW MULCH IF NOT IN SEEDING SEASON, (B) FLOW CHANNEL STABILIZATION PER THE STANDARD CHART BASED ON CHANNEL GRADE.

42 TYPICAL TEMPORARY EARTH DIKE
N.T.S.

CONSTRUCTION SPECIFICATIONS


- AREA UNDER EMBANKMENT SHALL BE CLEARED, GRUBBED AND STRIPPED OF ANY VEGETATION AND ROOT MAT. THE POOL AREA SHALL BE CLEARED.
- THE FILL MATERIAL FOR THE EMBANKMENT SHALL BE FREE OF ROOTS OR OTHER WOODY VEGETATION AS WELL AS OVER-SIZED STONES, ROCKS, ORGANIC MATERIAL, OR OTHER OBJECTIONABLE MATERIAL. THE EMBANKMENT SHALL BE COMPACTED BY TRAVERSING WITH EQUIPMENT WHILE IT IS BEING CONSTRUCTED.
- VOLUME OF SEDIMENT STORAGE SHALL BE 3600 CUBIC FEET PER ACRE OF CONTRIBUTORY DRAINAGE.
- SEDIMENT SHALL BE REMOVED AND TRAP RESTORED TO ITS ORIGINAL DIMENSIONS WHEN THE SEDIMENT HAS ACCUMULATED TO 1/2 THE DESIGN DEPTH OF THE TRAP. REMOVED SEDIMENT SHALL BE DEPOSITED IN A SUITABLE AREA AND STABILIZED.
- THE STRUCTURE SHALL BE INSPECTED AFTER EACH RAIN AND REPAIRS MADE AS NEEDED.
- CONSTRUCTION OPERATIONS SHALL BE CARRIED OUT IN SUCH A MANNER THAT EROSION AND SEDIMENT ARE CONTROLLED.
- THE STRUCTURE SHALL BE REMOVED AND AREA STABILIZED WHEN THE DRAINAGE AREA HAS BEEN PROPERLY STABILIZED.
- ALL FILL SLOPES SHALL BE 2:1 OR FLATTER; CUT SLOPES 1:1 OR FLATTER.
- ALL PIPE CONNECTIONS SHALL BE WATERTIGHT.
- THE TOP 2/3 OF THE RISER SHALL BE PERFORATED WITH ONE (1) INCH DIAMETER HOLES OR SLITS SPACED SIX (6) INCHES VERTICALLY AND HORIZONTALLY AND PLACED IN THE CONCAVE PORTION OF PIPE. NO HOLES WILL BE ALLOWED WITHIN SIX (6) INCHES OF THE HORIZONTAL BARREL.
- THE RISER SHALL BE WRAPPED WITH 1/4 TO 1/2 INCH HARDWARE CLOTH WIRE THEN WRAPPED WITH FILTER CLOTH (HAVING AN EQUIVALENT SIEVE SIZE OF 40-80). THE FILTER CLOTH SHALL EXTEND SIX (6) INCHES ABOVE THE HIGHEST HOLE AND SIX (6) INCHES BELOW THE LOWEST HOLE. WHERE ENDS OF THE FILTER CLOTH COME TOGETHER, THEY SHALL BE OVER-LAPPED, FOLDED AND STAPLED TO PREVENT BYPASS.
- STRAPS OR CONNECTING BANDS SHALL BE USED TO HOLD THE FILTER CLOTH AND WIRE FABRIC IN PLACE. THEY SHALL BE PLACED AT THE TOP AND BOTTOM OF THE CLOTH.
- FILL MATERIAL AROUND THE PIPE SPILLWAY SHALL BE HAND COMPACTED IN FOUR (4) INCH LAYERS. A MINIMUM OF TWO (2) FEET OF HAND COMPACTED BACKFILL SHALL BE PLACED OVER THE PIPE SPILLWAY BEFORE CROSSING IT WITH CONSTRUCTION EQUIPMENT.
- THE RISER SHALL BE ANCHORED WITH EITHER A CONCRETE BASE OR STEEL PLATE BASE TO PREVENT FLOTATION. FOR CONCRETE BASE THE DEPTH SHALL BE TWELVE (12) INCHES WITH THE RISER EMBEDDED NINE (9) INCHES. A 1/4 INCH MINIMUM THICKNESS STEEL PLATE SHALL BE ATTACHED TO THE RISER BY A CONTINUOUS WELD AROUND THE BOTTOM TO FORM A WATERTIGHT CONNECTION AND THEN PLACE TWO (2) FEET OF STONE, GRAVEL, OR TAMPED EARTH ON THE PLATE.

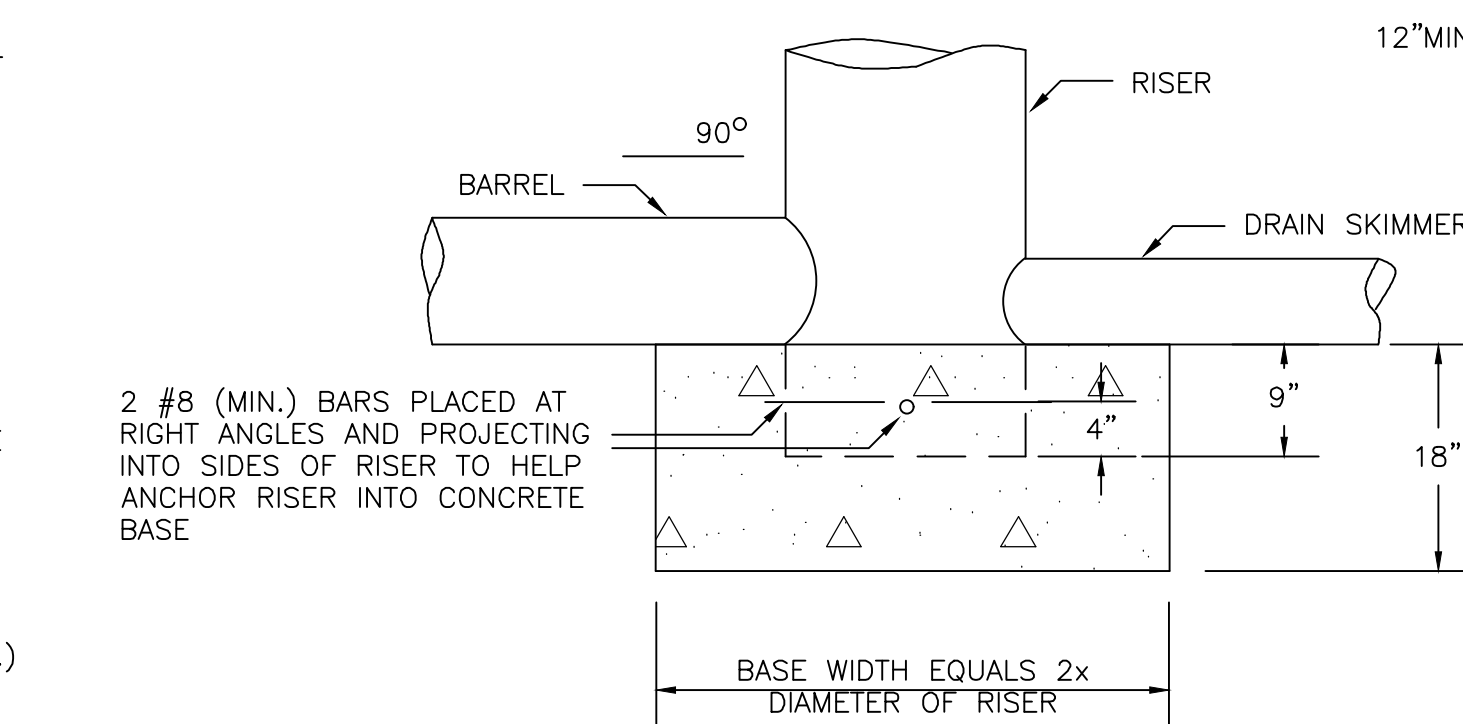

CONSTRUCTION SPECIFICATIONS


- THE CONCRETE BASE SHALL BE POURED IN SUCH A MANNER TO INSURE THAT THE CONCRETE FILLS THE BOTTOM OF THE RISER TO THE INVERT OF THE OUTLET PIPE TO PREVENT THE RISER FROM BREAKING AWAY FROM THE BASE.
- WITH ALUMINUM OR ALUMINIZED PIPE, THE EMBEDDED SECTION MUST BE PAINTED WITH CHROMATE OR EQUIVALENT.
- RISER BASE MAY BE SIZED AS COMPUTED USING FLOTATION WITH A FACTOR OF SAFETY OF 1.2.

43 RISER BASE DETAIL SEDIMENT BASIN
N.T.S.

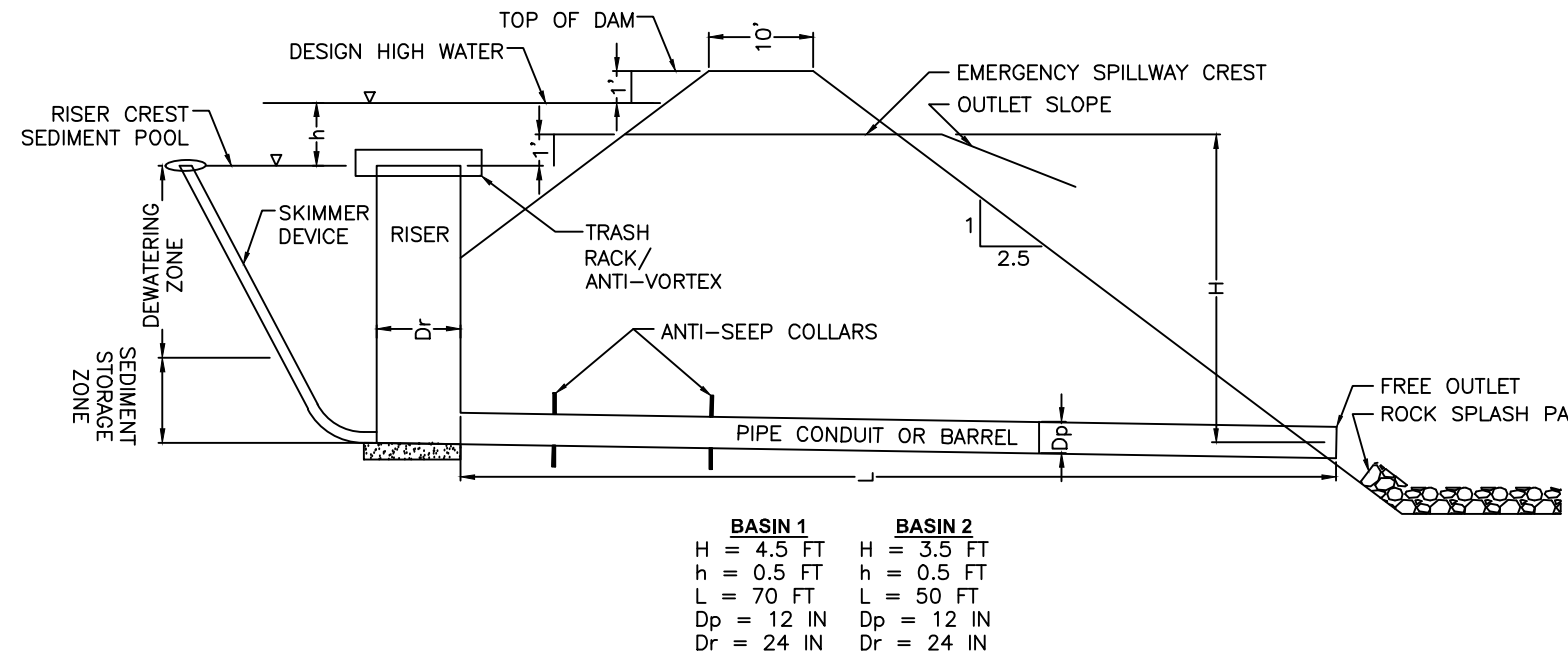


44 SEDIMENT BASIN PIPE SPILLWAY DESIGN
N.T.S.

OPTIONAL SEDIMENT BASIN DEWATERING DEVICE - I WITH 6" MIN. PERFORATED RISER

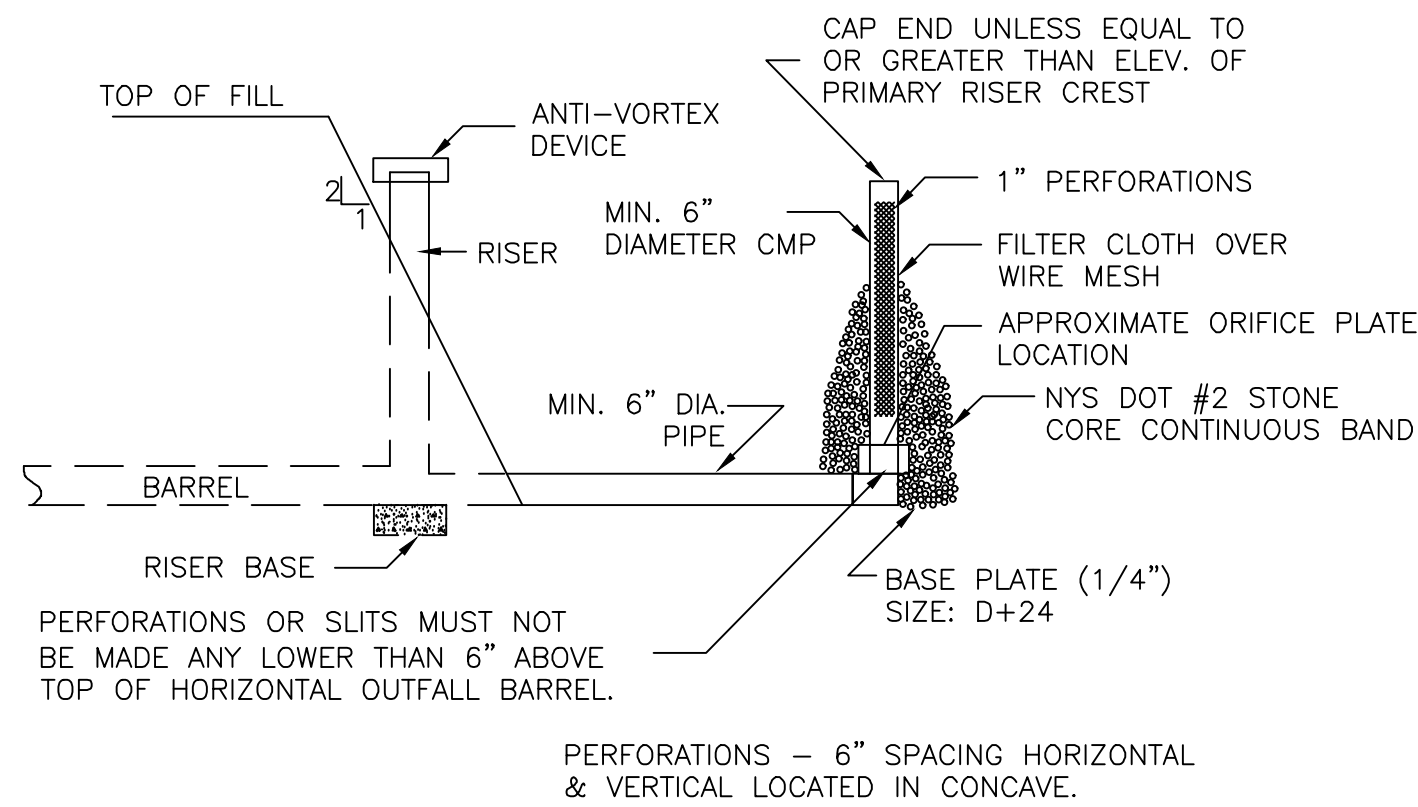

OPTIONAL SEDIMENT BASIN DEWATERING DEVICE - II

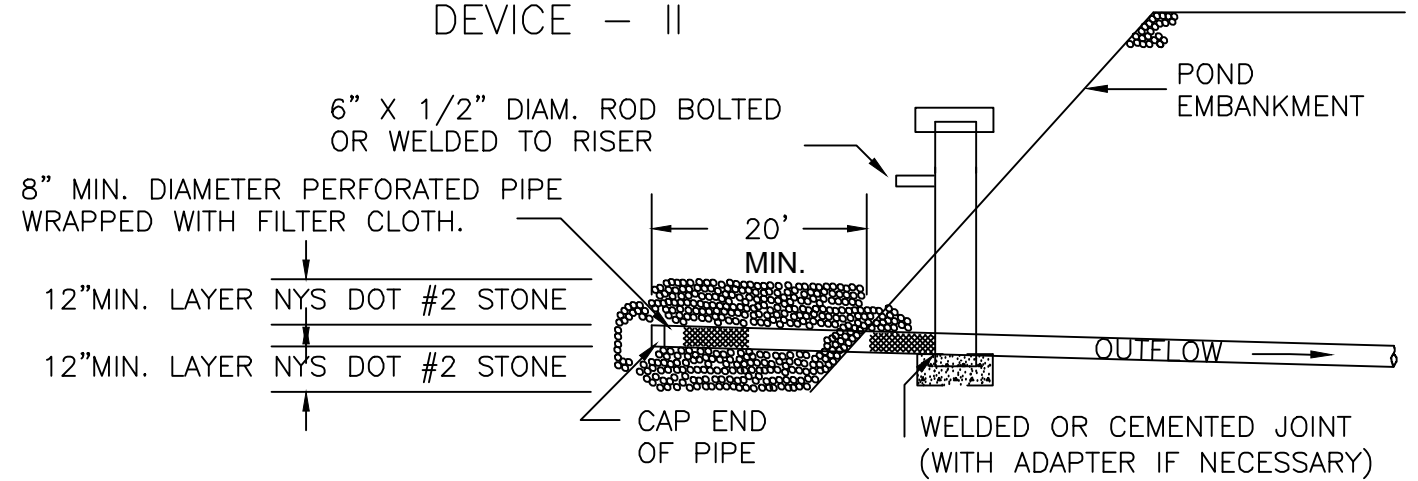

45 SEDIMENT BASIN RISER PIPE DEWATERING
N.T.S.

C	07/14/2021	JSD	ISSUED FOR 94C	KW	NJM
B	05/21/2021	RCB	ISSUED FOR REVIEW	KW	NJM
A	01/29/2021	RCB	ISSUED FOR REVIEW	KW	NJM
Rev	Date	Drawn	Description	Ch'k'd	App'd

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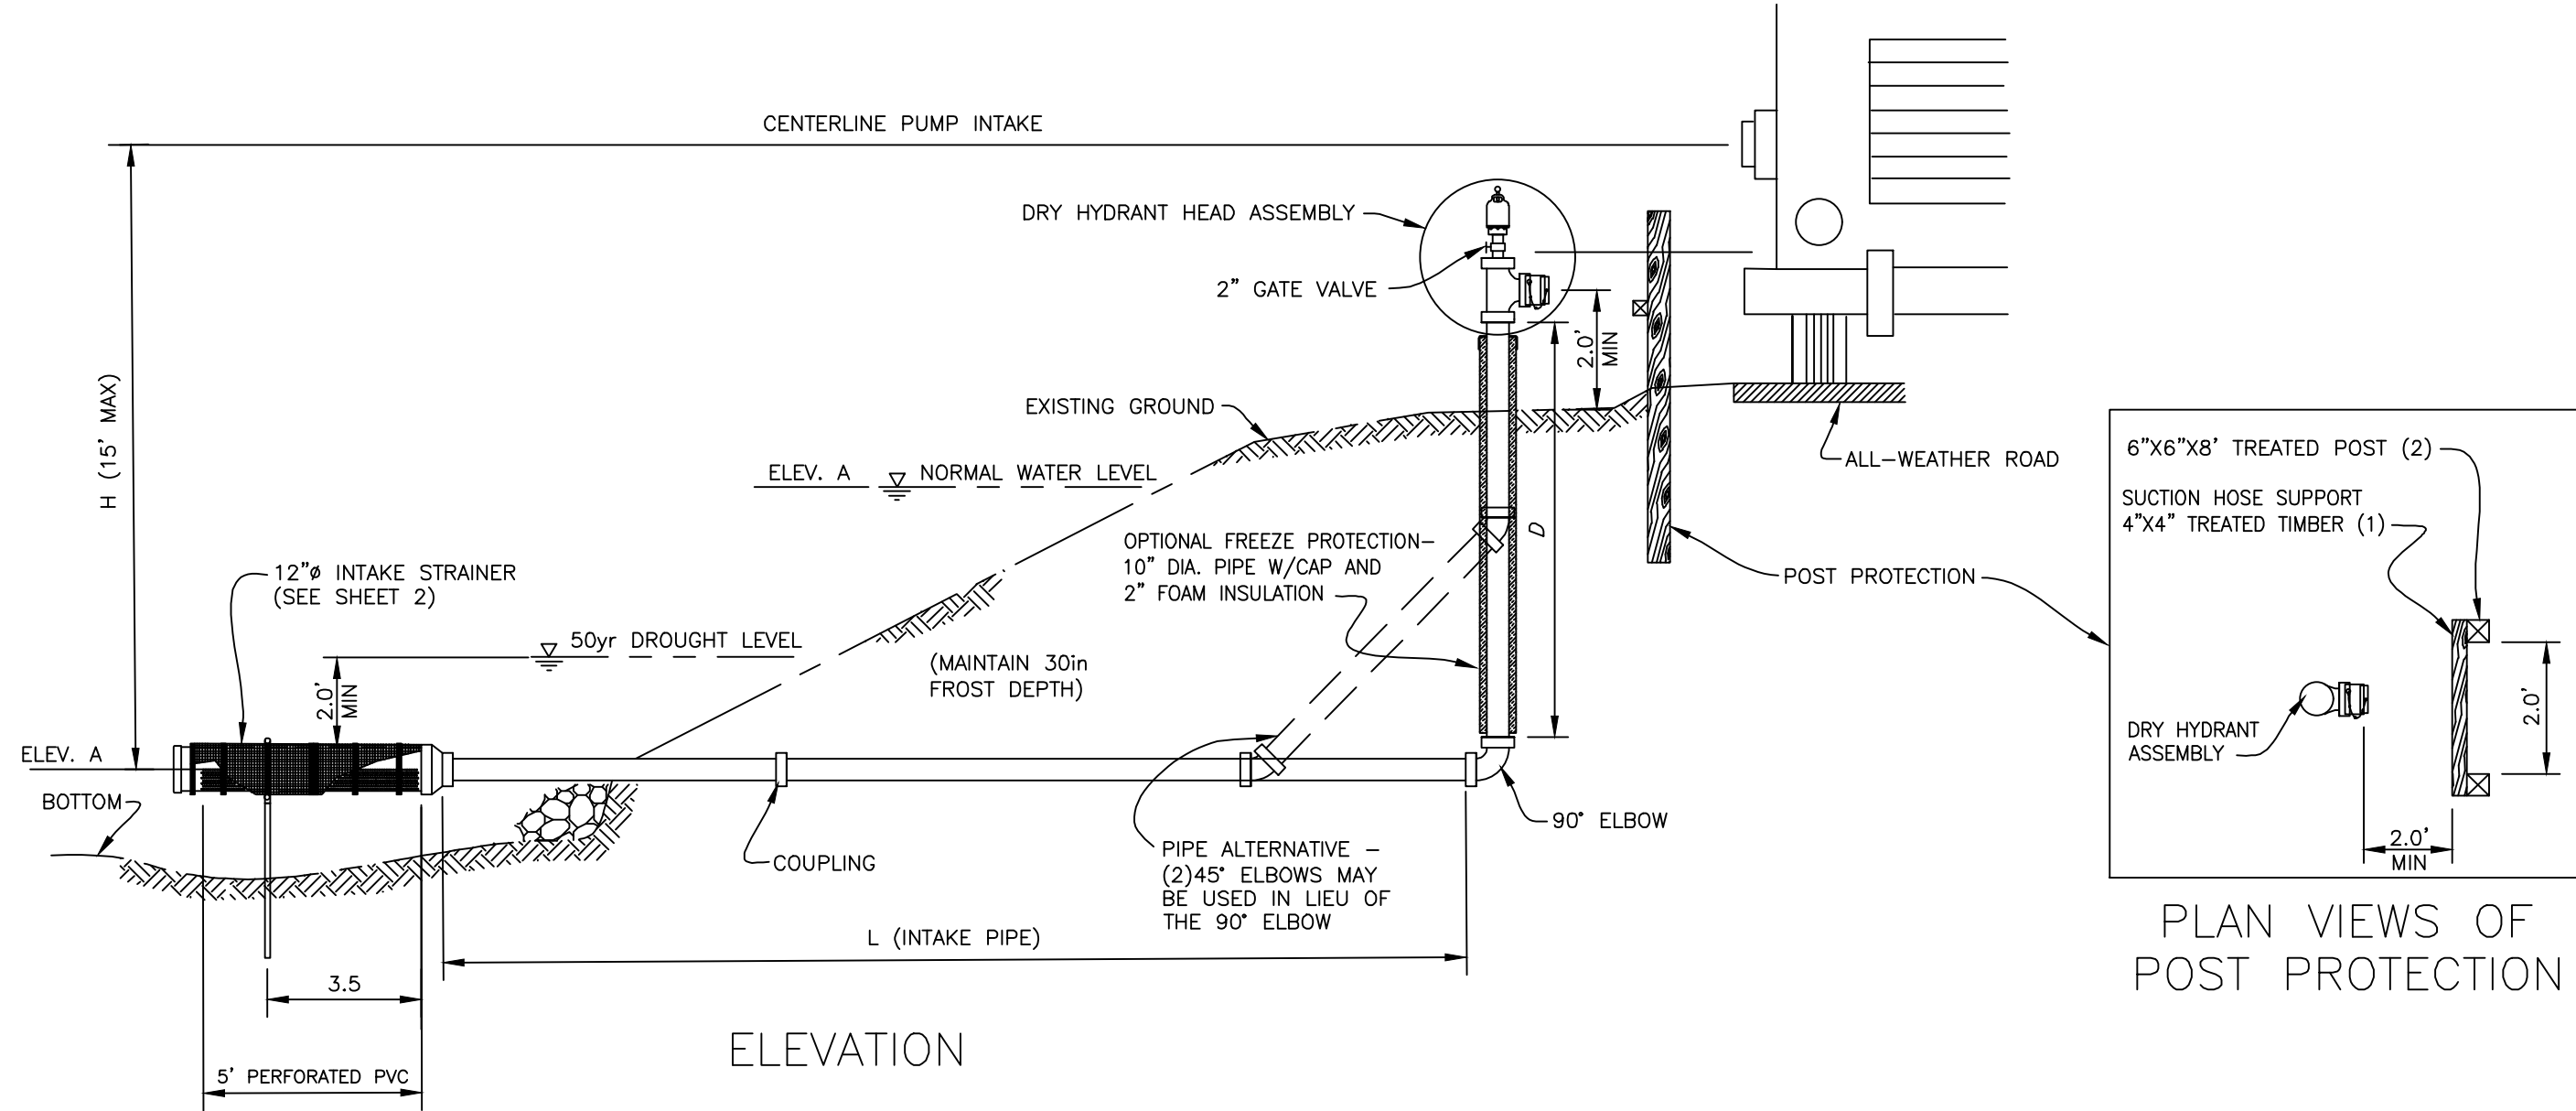


SOUTH RIPLEY SOLAR
TYPICAL CIVIL DETAILS
SHEET 9 OF 10

PRELIMINARY
NOT FOR
CONSTRUCTION
REPLACE WITH
ENGINEERS STAMP
AT CONSTRUCTION
AND/OR FABRICATION

Designed	MU	Eng check	KW
Drawn	RCB	Approved	NJM
Scale at ANSI D NTS	Date 07/14/2021	Rev C	
Drawing Number	SRS-C-101-09		

CONCEPTUAL - NOT FOR CONSTRUCTION



DIMENSIONS:

D = _____ (ft)
H = _____ (ft)
L = _____ (ft)
ELEV. A = _____
ELEV. B = _____


DRY HYDRANT HEAD ASSEMBLY INCLUDES TEE, WITH AIR VENT, 2 INCH GATE VALVE, 6 INCH DRY HYDRANT HEAD, STRAINER, SNAP RING, SNAP-ON CAP WITH STAINLESS STEEL WIRE ROPE AND SUCTION HOSE ADAPTER, AND SHALL CONFORM TO ASTM 2466 SCHEDULE 40

THIS INSTALLATION DESIGNED FOR _____ gpm

GENERAL NOTES

1. THIS DRAWING REQUIRES SUPPORTING TECHNICAL DOCUMENTATION PRIOR TO USE AND MUST BE ADAPTED TO THE SPECIFIC SITE.
2. CONTRACTOR IS RESPONSIBLE FOR LOCATING, DISCONNECTION, RECONNECTING SERVICES TO ANY UTILITIES ENCOUNTERED AND WILL OBTAIN ALL REQUIRED PERMITS PRIOR TO INSTALLATION. SERVICES WILL BE RESTORED ASAP.
3. PUMP SITE SHALL BE AT AN ELEVATION THAT WILL ENSURE THE SUCTION INLET OF PUMP ON TRUCK IS ABOVE THE DRY HYDRANT HEAD ASSEMBLY.
4. ALL DISTURBED AREA SHALL BE VEGETATED IN ACCORDANCE WITH NRCS STANDARDS AND SPECIFICATIONS FOR CRITICAL AREA TREATMENT.
5. ALL PVC PIPING OR FITTINGS EXPOSED TO SUNLIGHT SHALL BE PRIMED AND PAINTED WITH REFLECTIVE MATERIAL.
6. A 6 INCH NHT (AMERICAN NATIONAL FIRE HOSE THREAD) DRY HYDRANT HEAD WILL BE UTILIZED TO MAKE CONNECTION TO THE FIRE TRUCK HOSE. THE SLEEVE WILL BE MADE OF BRASS OR ALUMINUM AND IT WILL BE PERMANENTLY ATTACHED TO THE PVC PIPE WITH STAINLESS STEEL BOLTS AND EPOXY ADHESIVE.
7. ALL HYDRANTS SHALL CONTAIN A REMOVABLE HEAD STRAINER AND STAINLESS STEEL SNAP RING THAT CAN BE REMOVED WITHOUT SPECIAL TOOLS. THE STRAINER SHALL BE CONICAL IN SHAPE TO MAXIMIZE STRAINER AREA. ALL HYDRANTS USE A RUBBER "O" RING BETWEEN THE THREADED SLEEVE AND THE PVC PIPE.
8. DRY HYDRANT CAPS SHALL BE SNAP ON/SNAP OFF DESIGN AND REMOVABLE WITHOUT SPECIAL TOOLS. IT SHALL BE PERMANENTLY ATTACHED TO HEAD WITH A CHAIN OR CABLE. THE CAP SHALL BE EITHER PLASTIC OR BRASS.


46 TYPICAL DRY HYDRANT DETAIL
N.T.S.

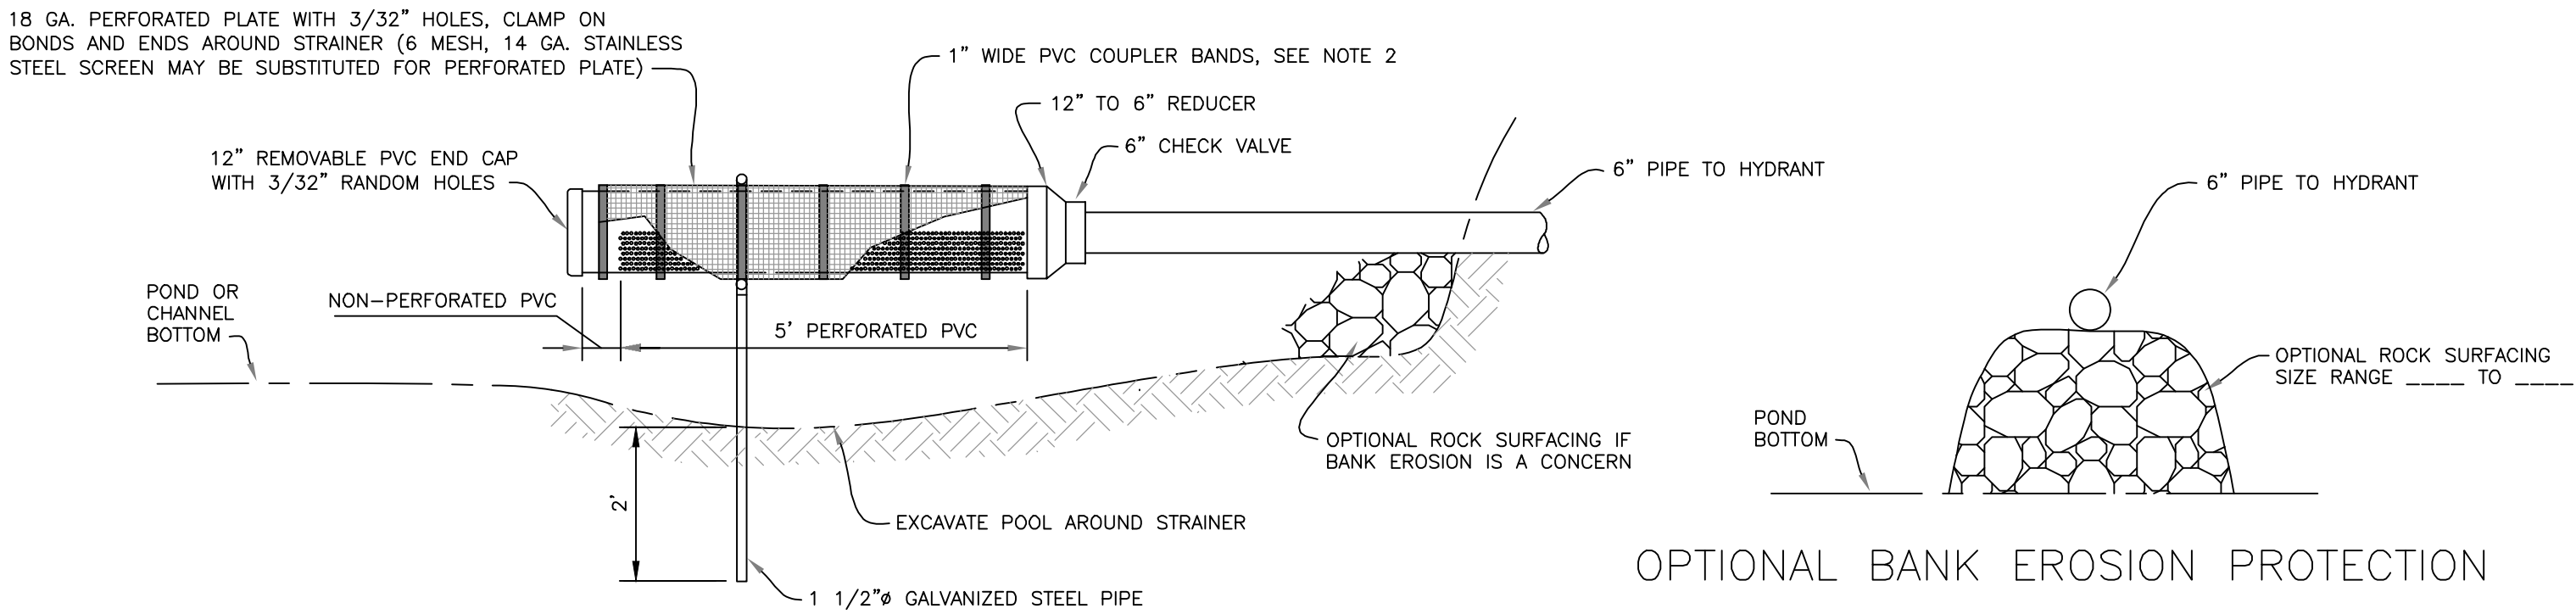

INTAKE STRAINER DETAIL

GENERAL NOTES

1. INTAKE STRAINER SHALL BE 12" DIAMETER AND 60" LONG. STRAINER WILL HAVE 1920 -3/8" HOLES ON BOTTOM OF PIPE TO MEET 0.4 FT/SEC VELOCITY ON FISH-BEARING STREAMS
2. PLACE END CAP WITH 3/32" HOLES ON STRAINER . USE 1" WIDE COUPLING SECTION BANDS SPACED AT 1 FT. INTERVALS TO HOLD SCREEN OFF STRAINER ASSEMBLY.
3. WRAP STRAINER WITH 18 GA. PERFORATED PLATE WITH 3/32" HOLES AND CLAMP TO OUTSIDE OF STRAINER, CLAMP ON EACH BAND AND ENDS. A 6 MESH, 14 GA. STAINLESS STEEL SCREEN MAY BE SUBSTITUTED FOR THE PERFORATED PLATE.
4. USE 12" TO 6" REDUCER AND 6" CHECK VALVE IN SUPPLY LINE TO HYDRANT.
5. ALL PVC PIPING OR FITTINGS EXPOSED TO SUNLIGHT SHALL BE PRIMED AND PAINTED WITH REFLECTIVE MATERIAL.

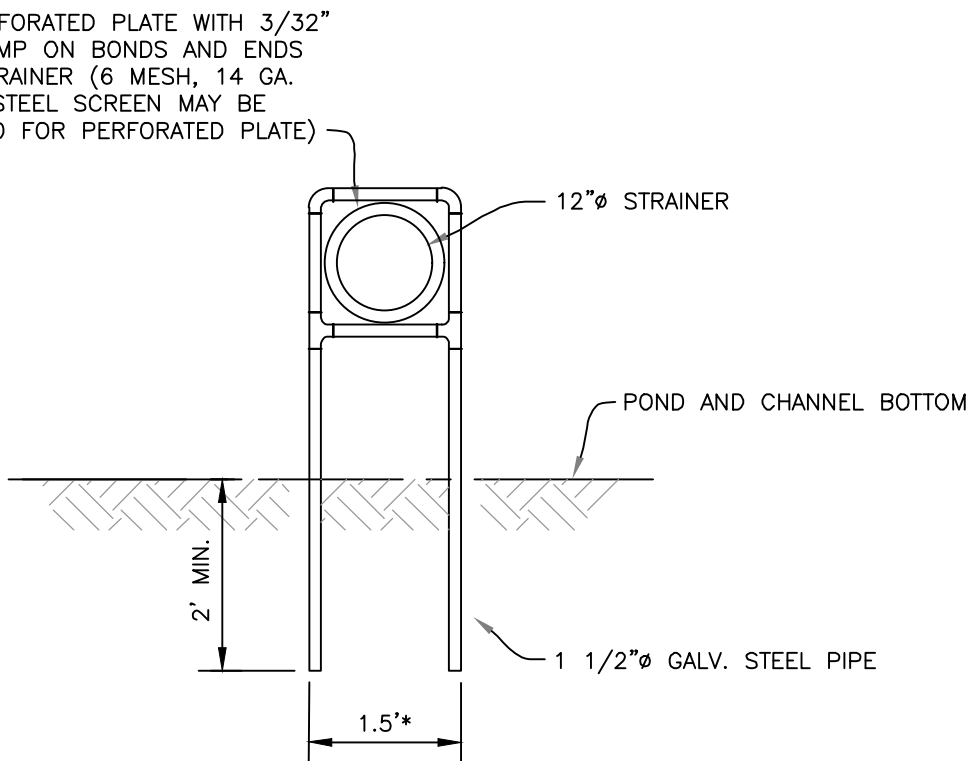

* PUSH INTO BOTTOM WITH HOE, ADJUST WIDTH AND HEIGHT TO FIT STRAINER AND SCREEN ASSEMBLY

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B	05/21/2021	RCB	ISSUED FOR REVIEW	KW	NJM
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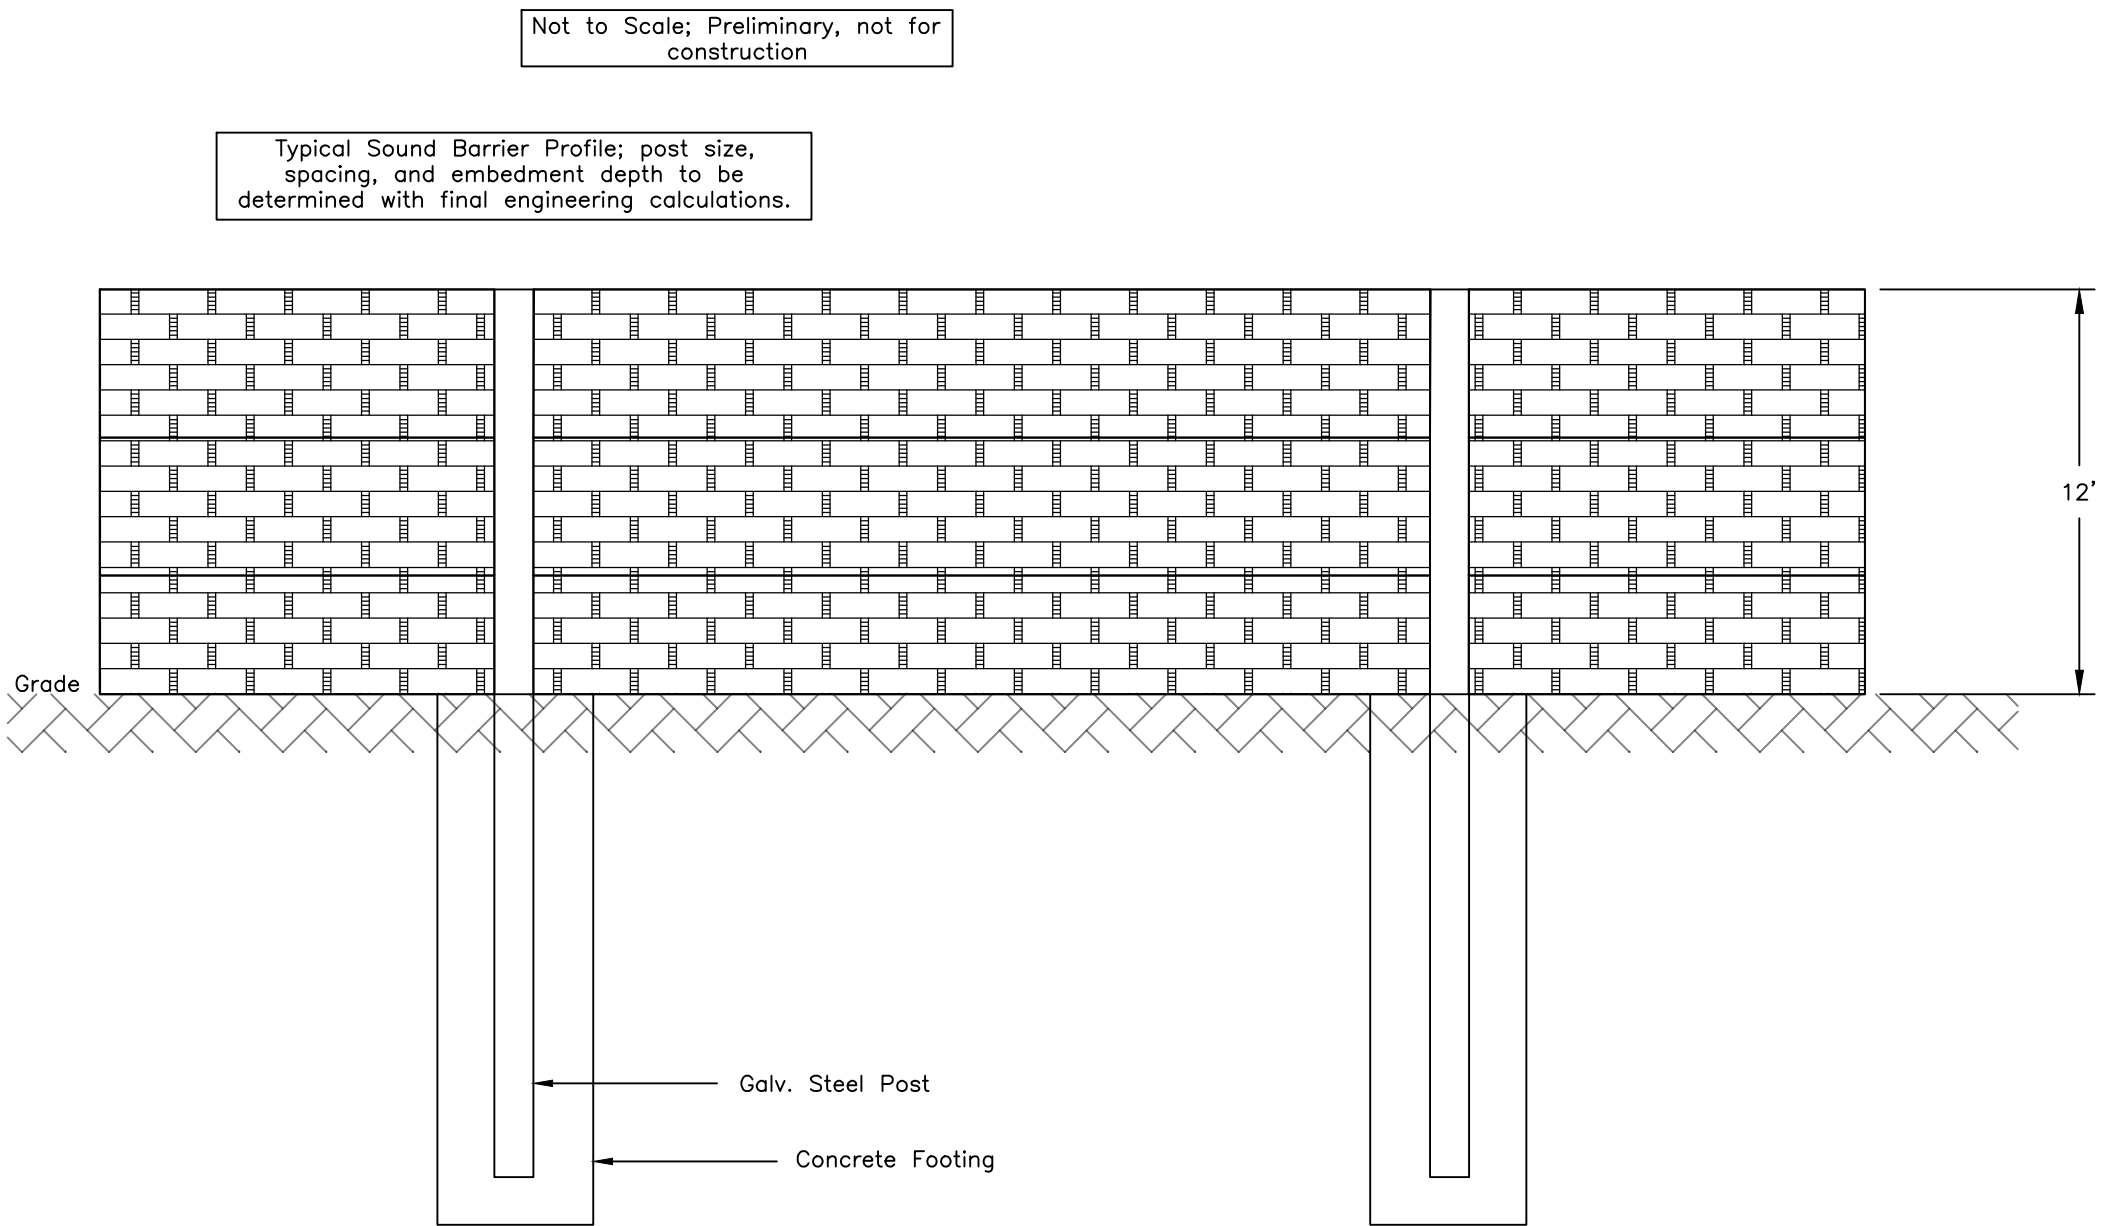
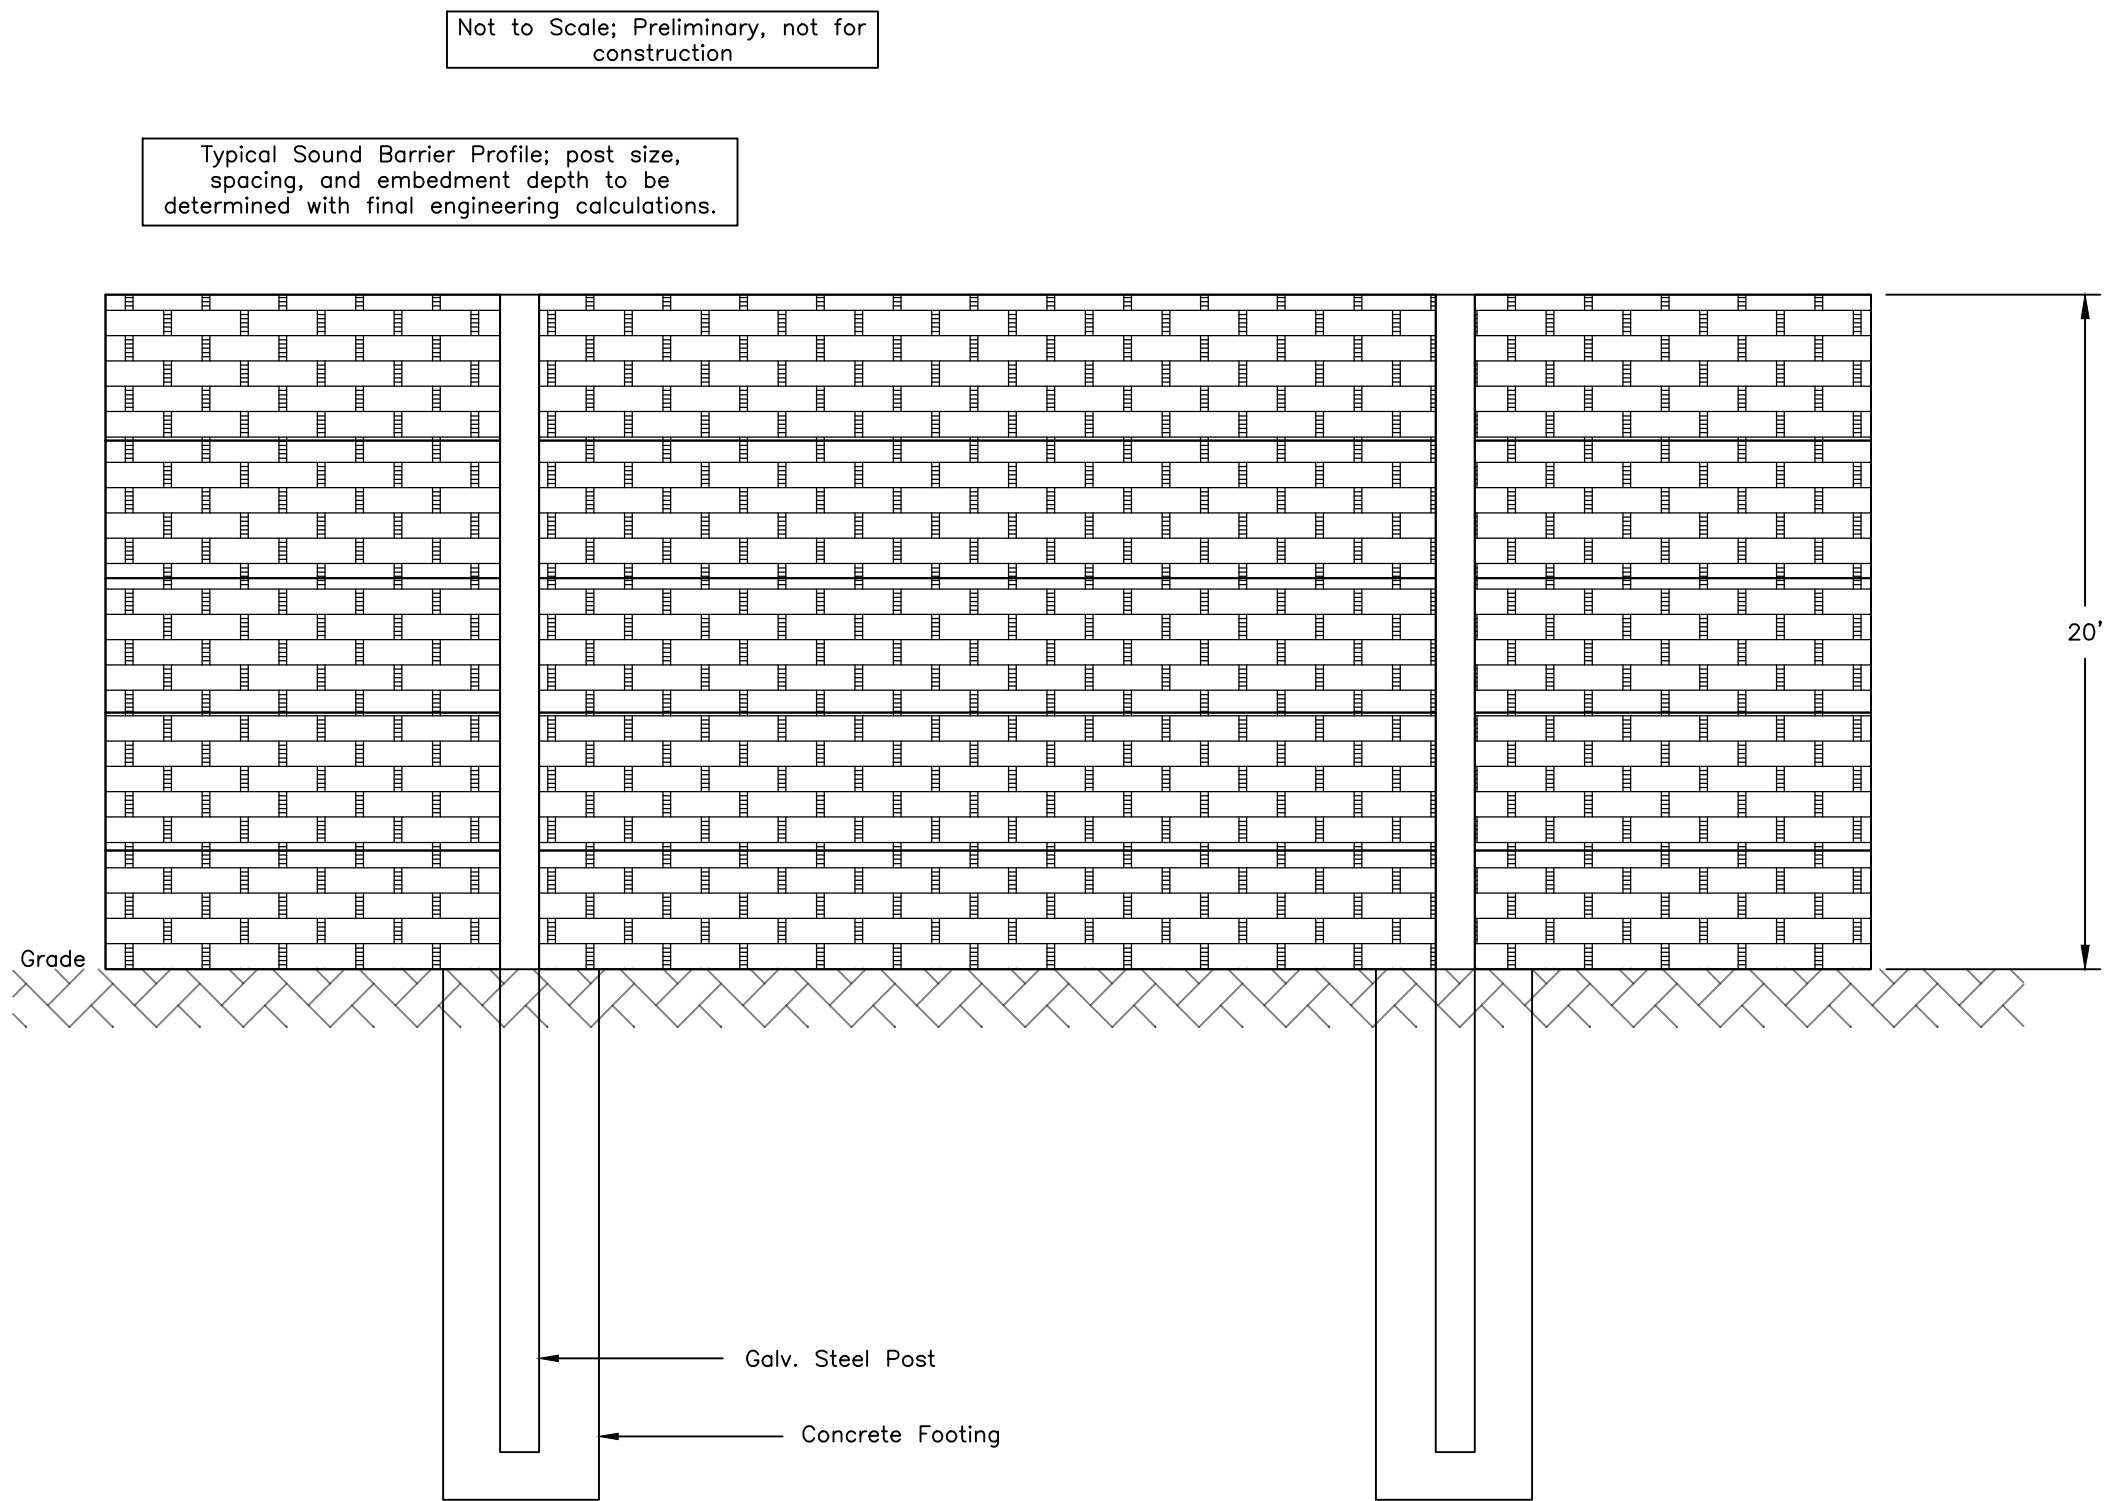
Title
SOUTH RIPLEY SOLAR
TYPICAL CIVIL DETAILS
SHEET 10 OF 10

PRELIMINARY
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ENGINEERS STAMP
AT CONSTRUCTION
AND/OR FABRICATION

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Scale at ANSI D NTS	Date 07/14/2021	Rev C	
Drawing Number	SRS-C-101-10		


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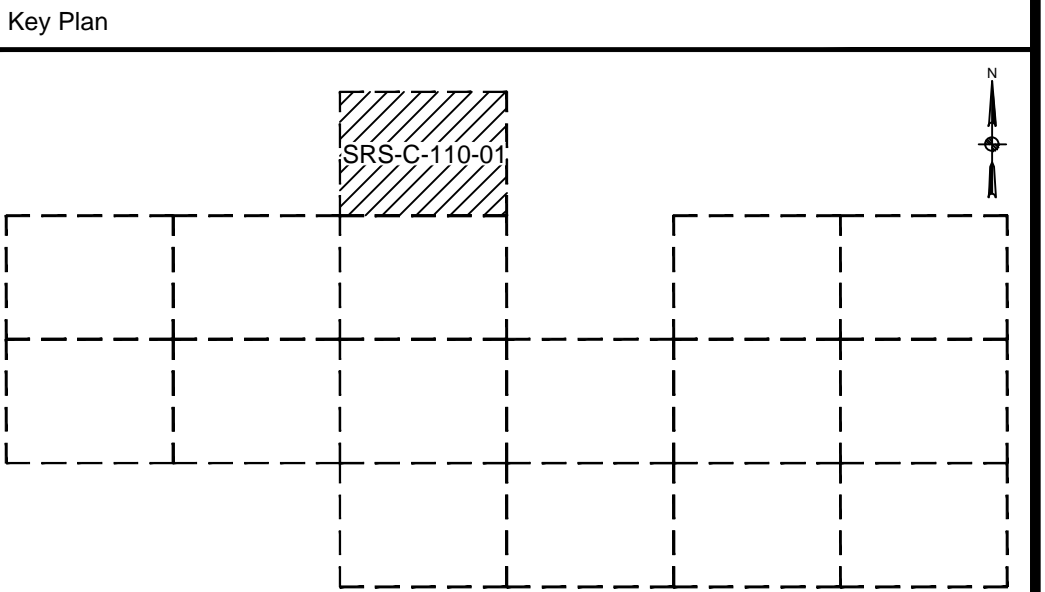


47 SOUNDWALL CONSTRUCTION DETAIL
N.T.S.

A	01/10/2022	RCB	ISSUED FOR 94-C-SUPPLEMENT A	KW	NUM
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Client					
<div><div><div>G</div><div>South Ripley SOLAR PROJECT</div></div></div>					
Title					
SOUTH RIPLEY SOLAR TYPICAL CIVIL DETAILS					
PRELIMINARY NOT FOR CONSTRUCTION REPLACE WITH ENGINEERS STAMP AT CONSTRUCTION AND/OR FABRICATION			Designed	MU	Eng check
			Drawn	RCB	Approved
			Scale at ANSI D NTS		Date
			Drawing Number		Rev
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	EXISTING MINOR CONTOUR
	EXISTING TREELINE
	EXISTING GAS LINE & EASEMENT
	GAS WELLS
	WETLANDS - FEDERAL
	WETLANDS - NYSDEC JURISDICTIONAL
	STREAMS - FEDERAL
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	FEDERAL WETLANDS/STREAMS - SETBACK
	WETLANDS/STREAMS - SETBACK
	OCCUPIED RESIDENCES
	OCCUPIED RESIDENCE SETBACK
	TREE CLEARING ONLY
	TREE CLEARING & CLEARING/GRUBBING
	LIMITS OF DISTURBANCE
	DRAWING NUMBER
	DRAWING SHEET MATCH LINE



Rev	Date	Drawn	Description	Ch'k'd	App'd
C	07/14/2021	JSD	ISSUED FOR 94C	KW	NJM
B	05/21/2021	RCB	ISSUED FOR REVIEW	KW	NJM
A	01/29/2021	RCB	ISSUED FOR REVIEW	KW	NJM
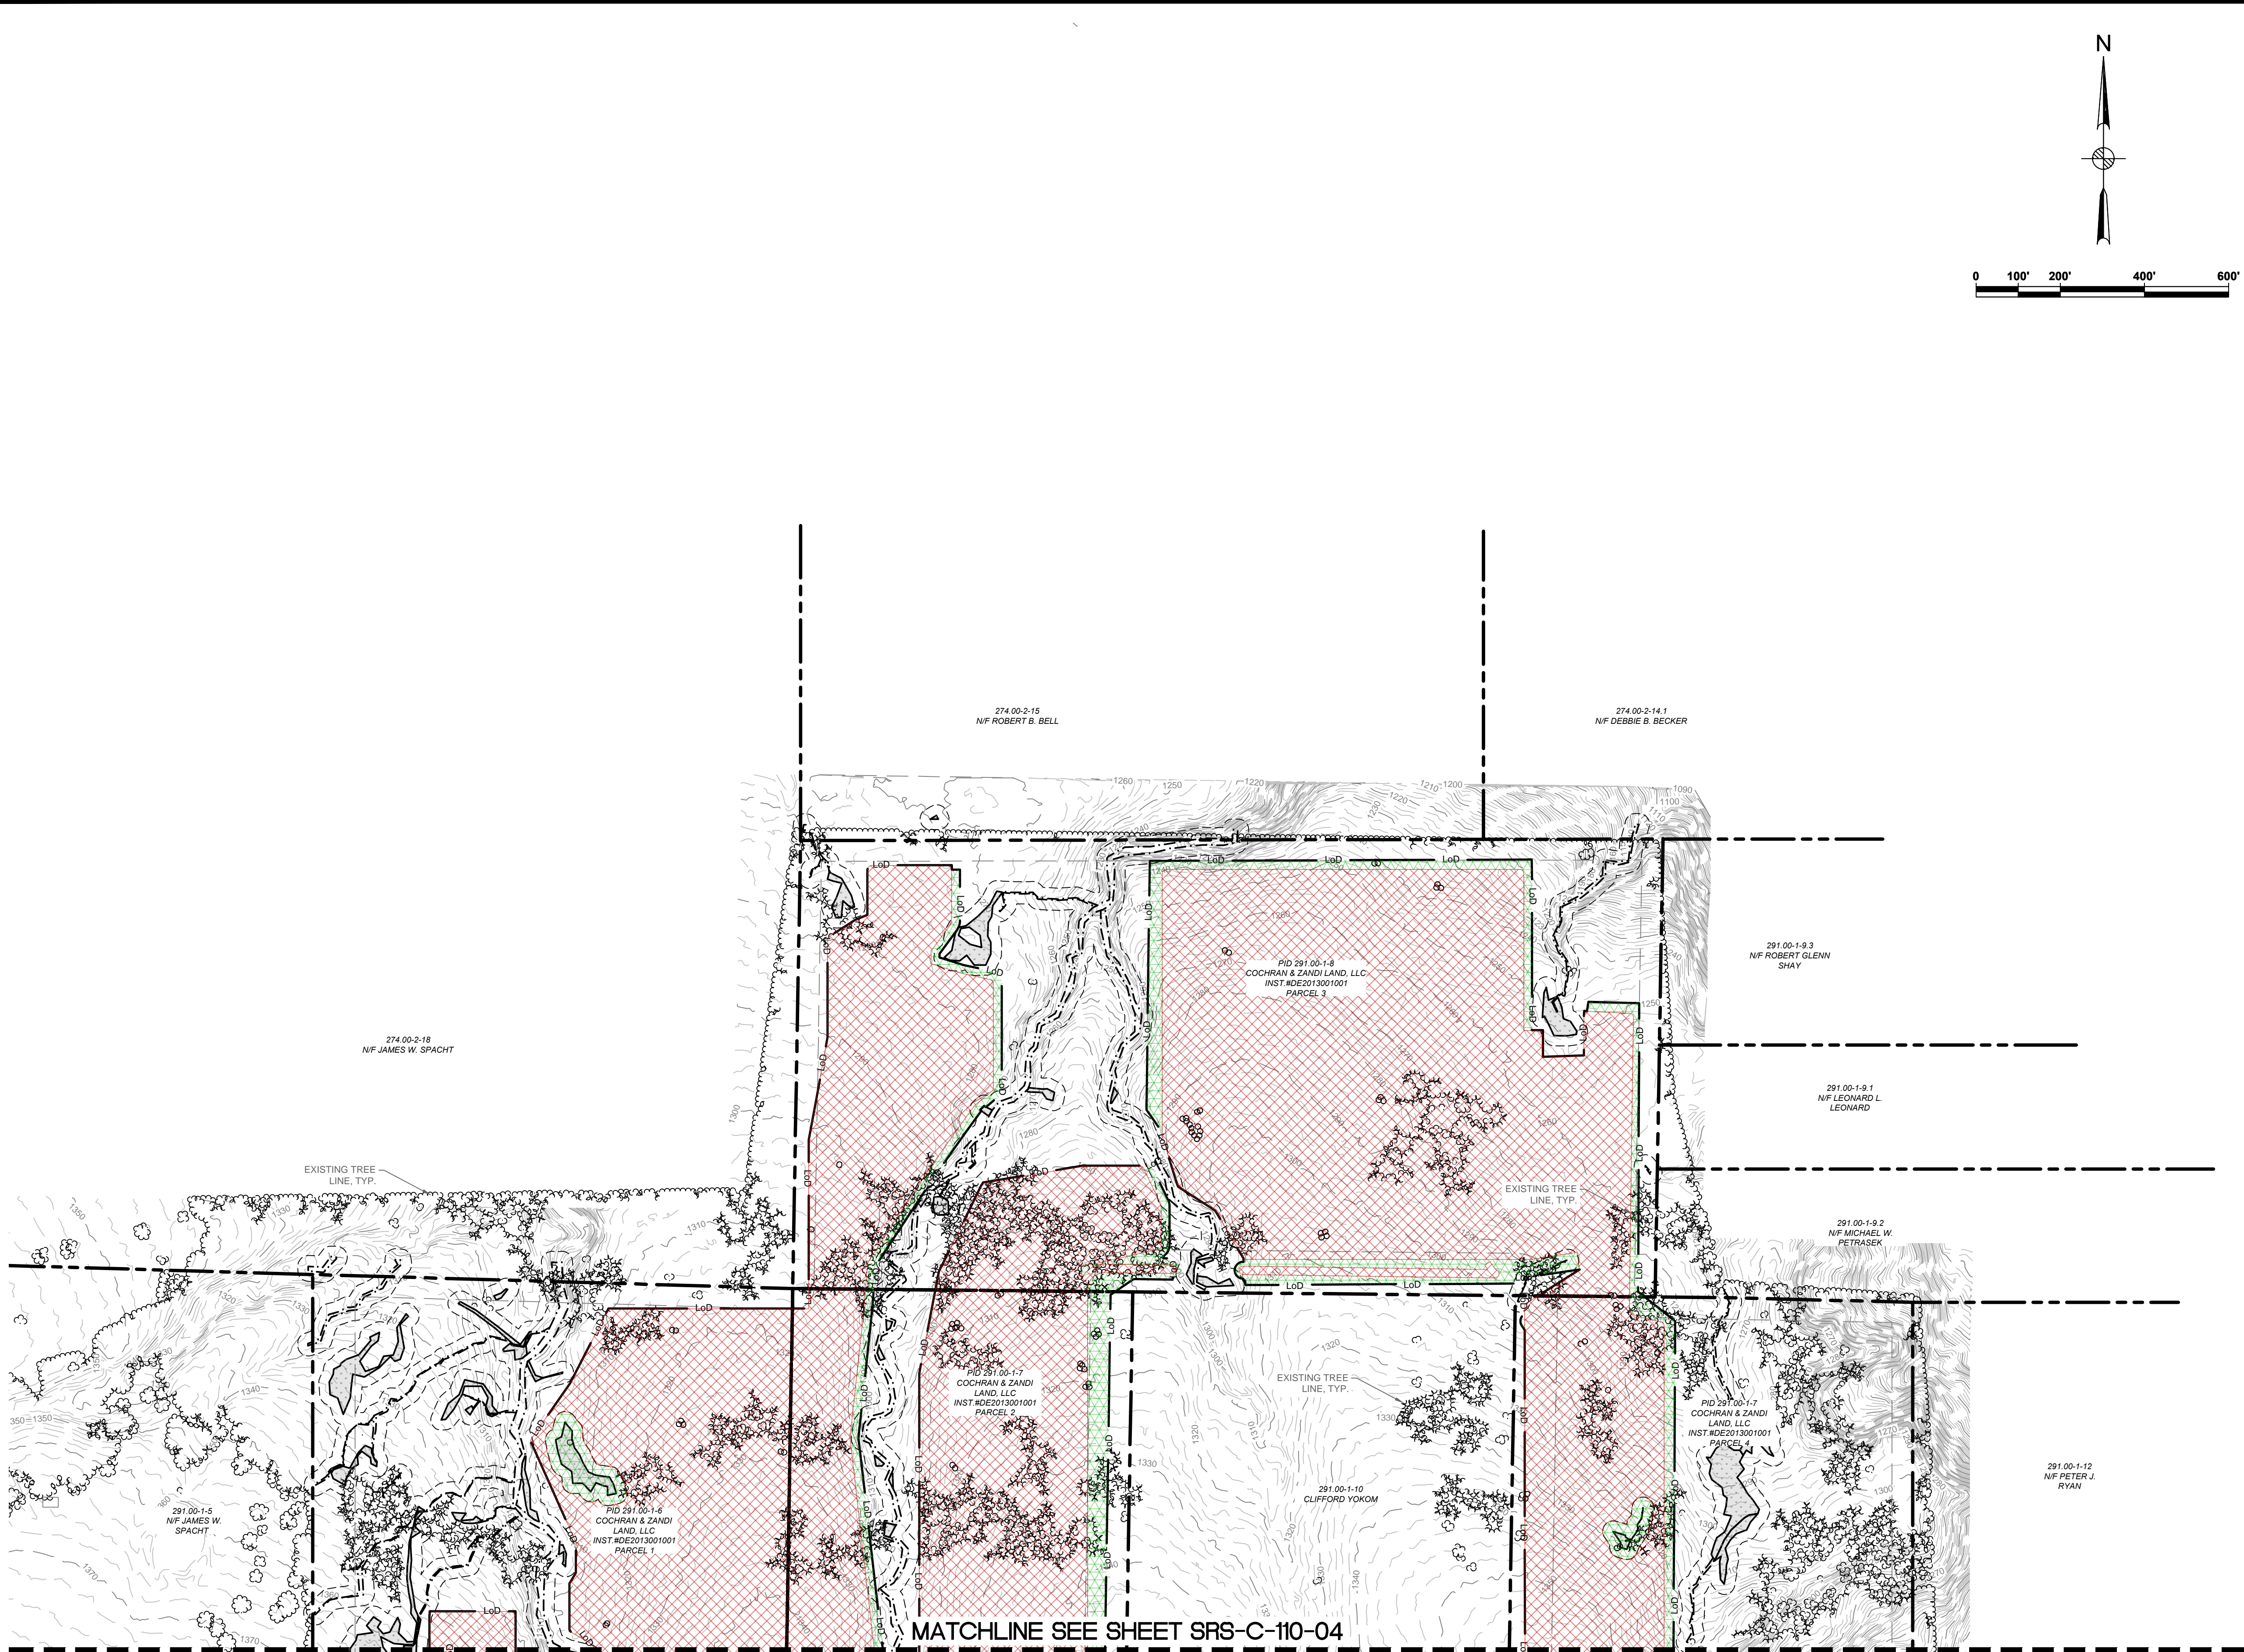
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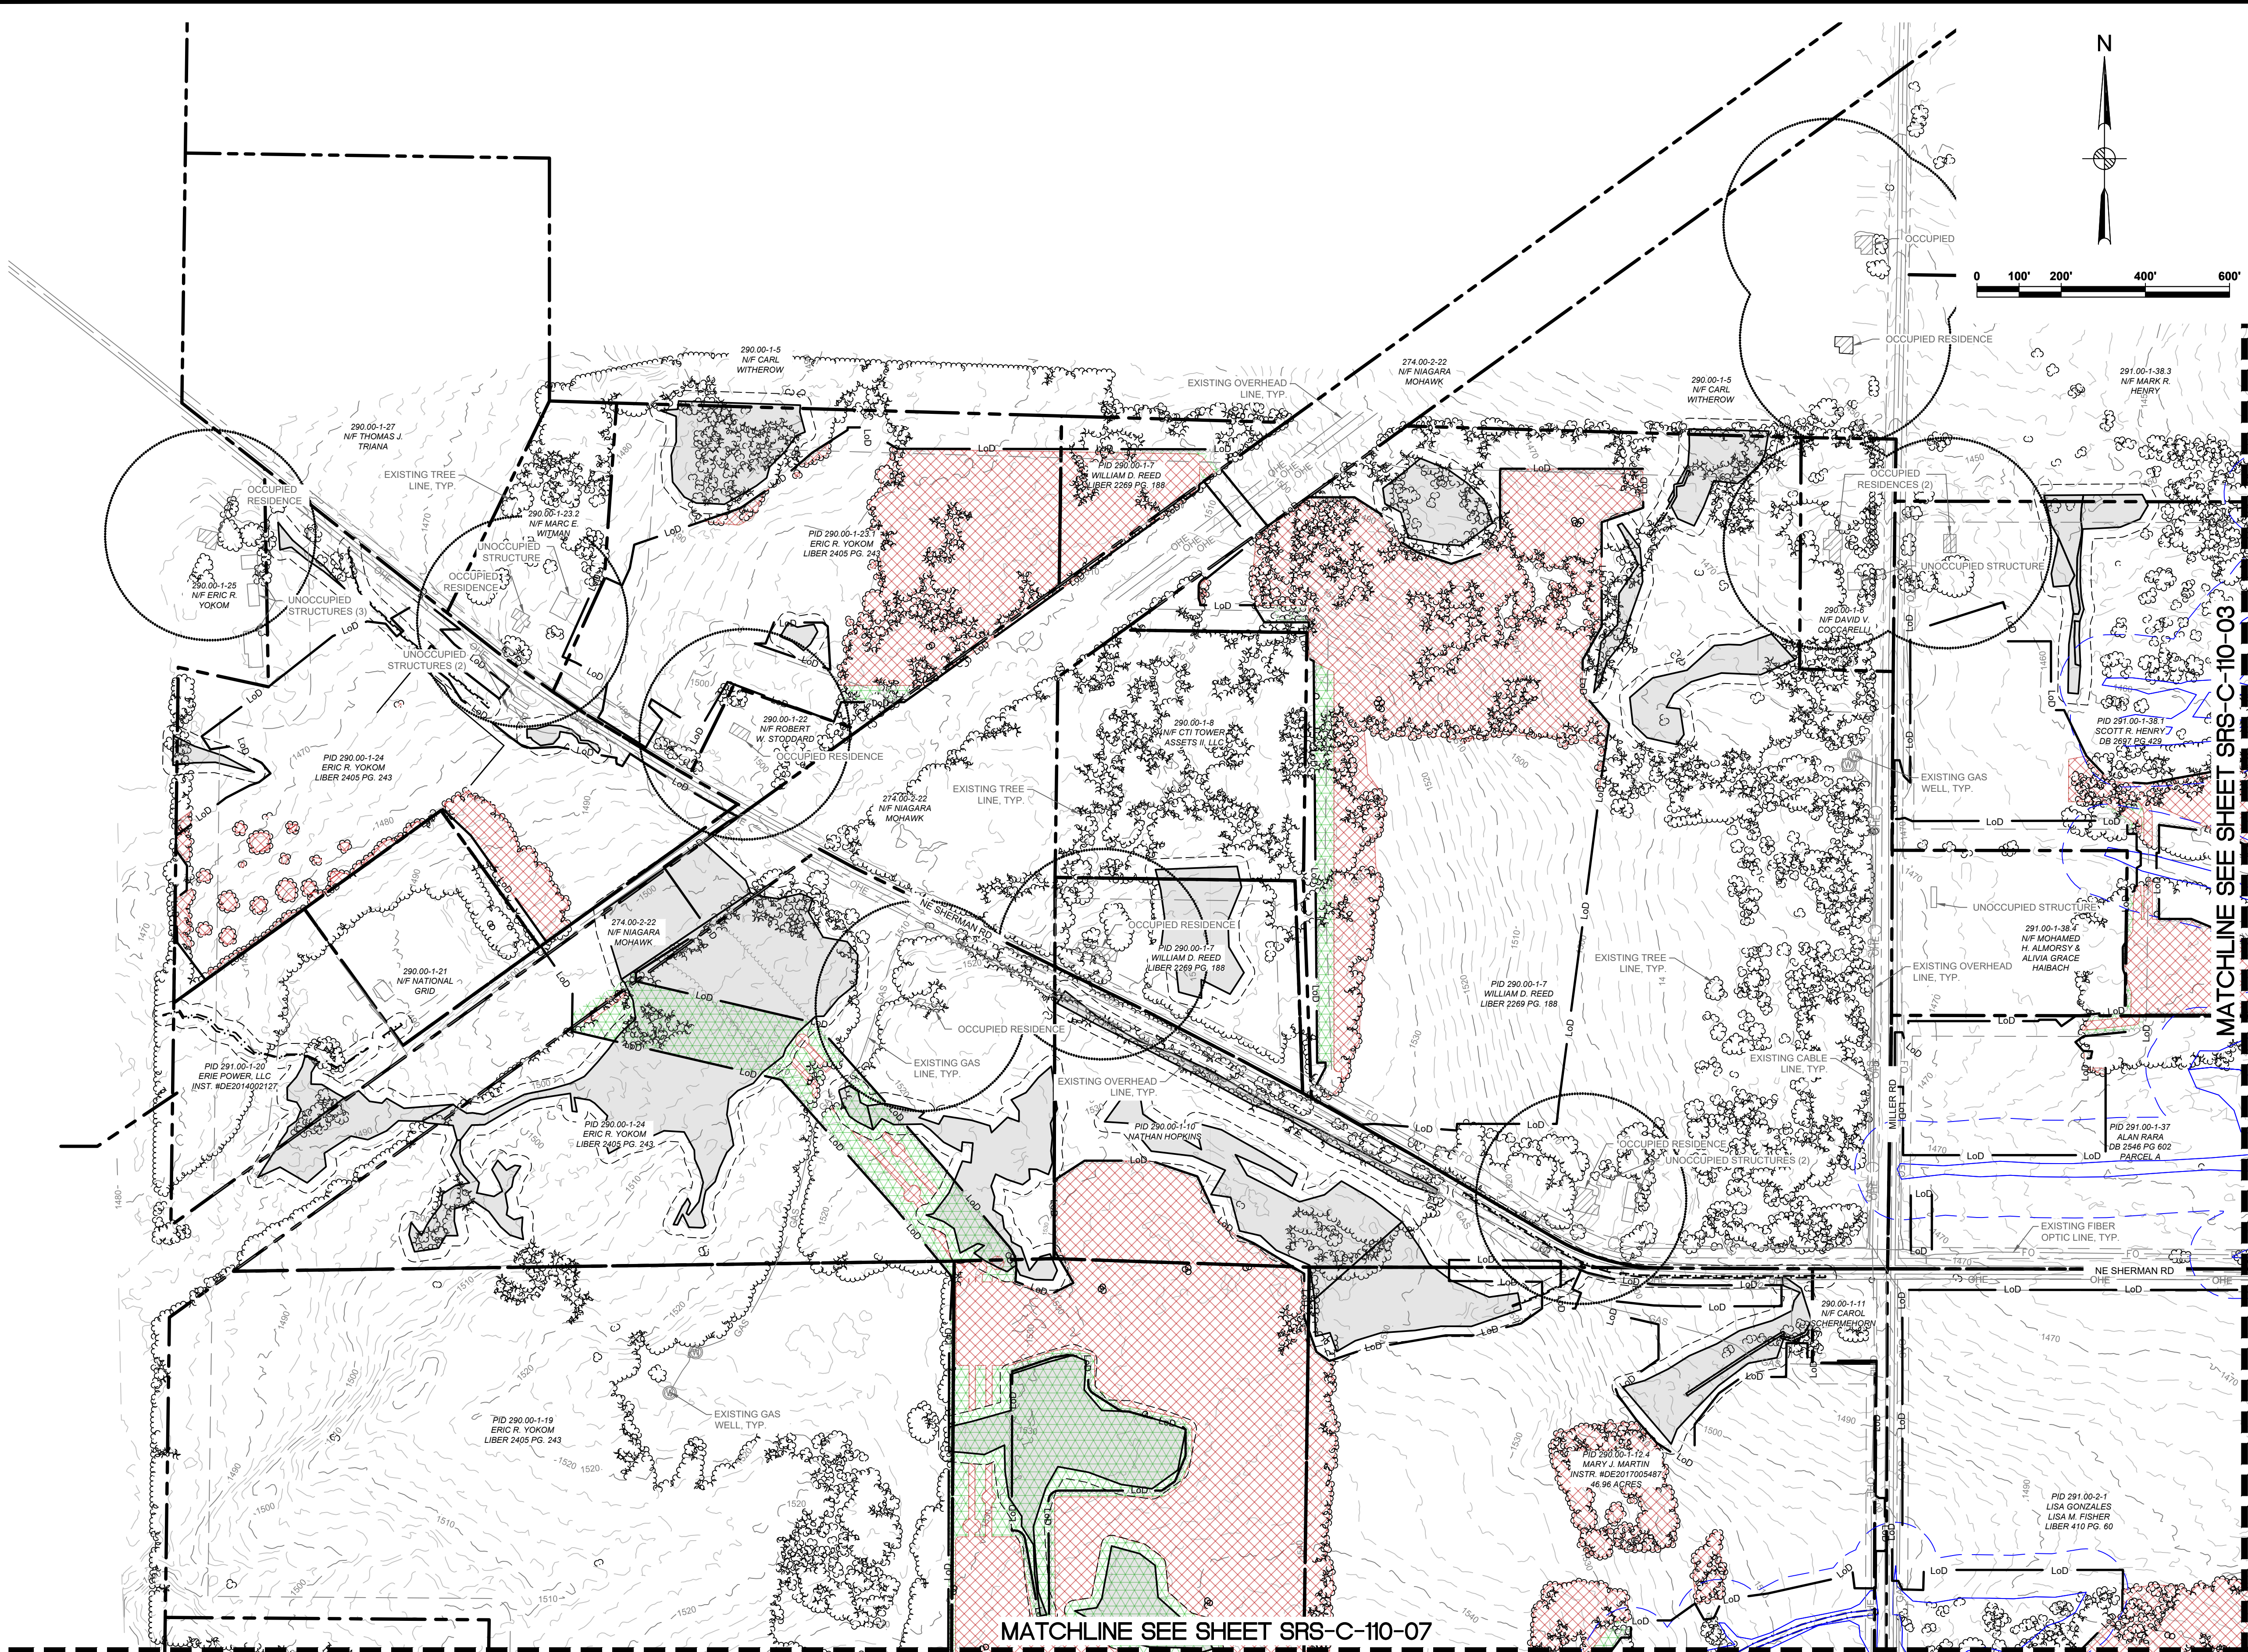
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**SOUTH RIPLEY SOLAR
EXISTING CONDITIONS
& CLEARING PLAN
SITE 1**

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	Dwg check		Project Mngr	
	Scale at ANSI D 1" = 200'	Date	07/14/2021	Rev C
Drawing Number SRS-C-110-01				


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	PROPERTY LINE SETBACKS
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	EXISTING MINOR CONTOUR
	EXISTING TREELINE
	EXISTING GAS LINE & EASEMENT
	GAS WELLS
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	DRAWING SHEET MATCH LINE



B	12/08/2021	RCB	ISSUED FOR 94-C-SUPPLEMENT A	KW	NJM
A	11/24/2021	RCB	ISSUED FOR REVIEW	KW	NJM
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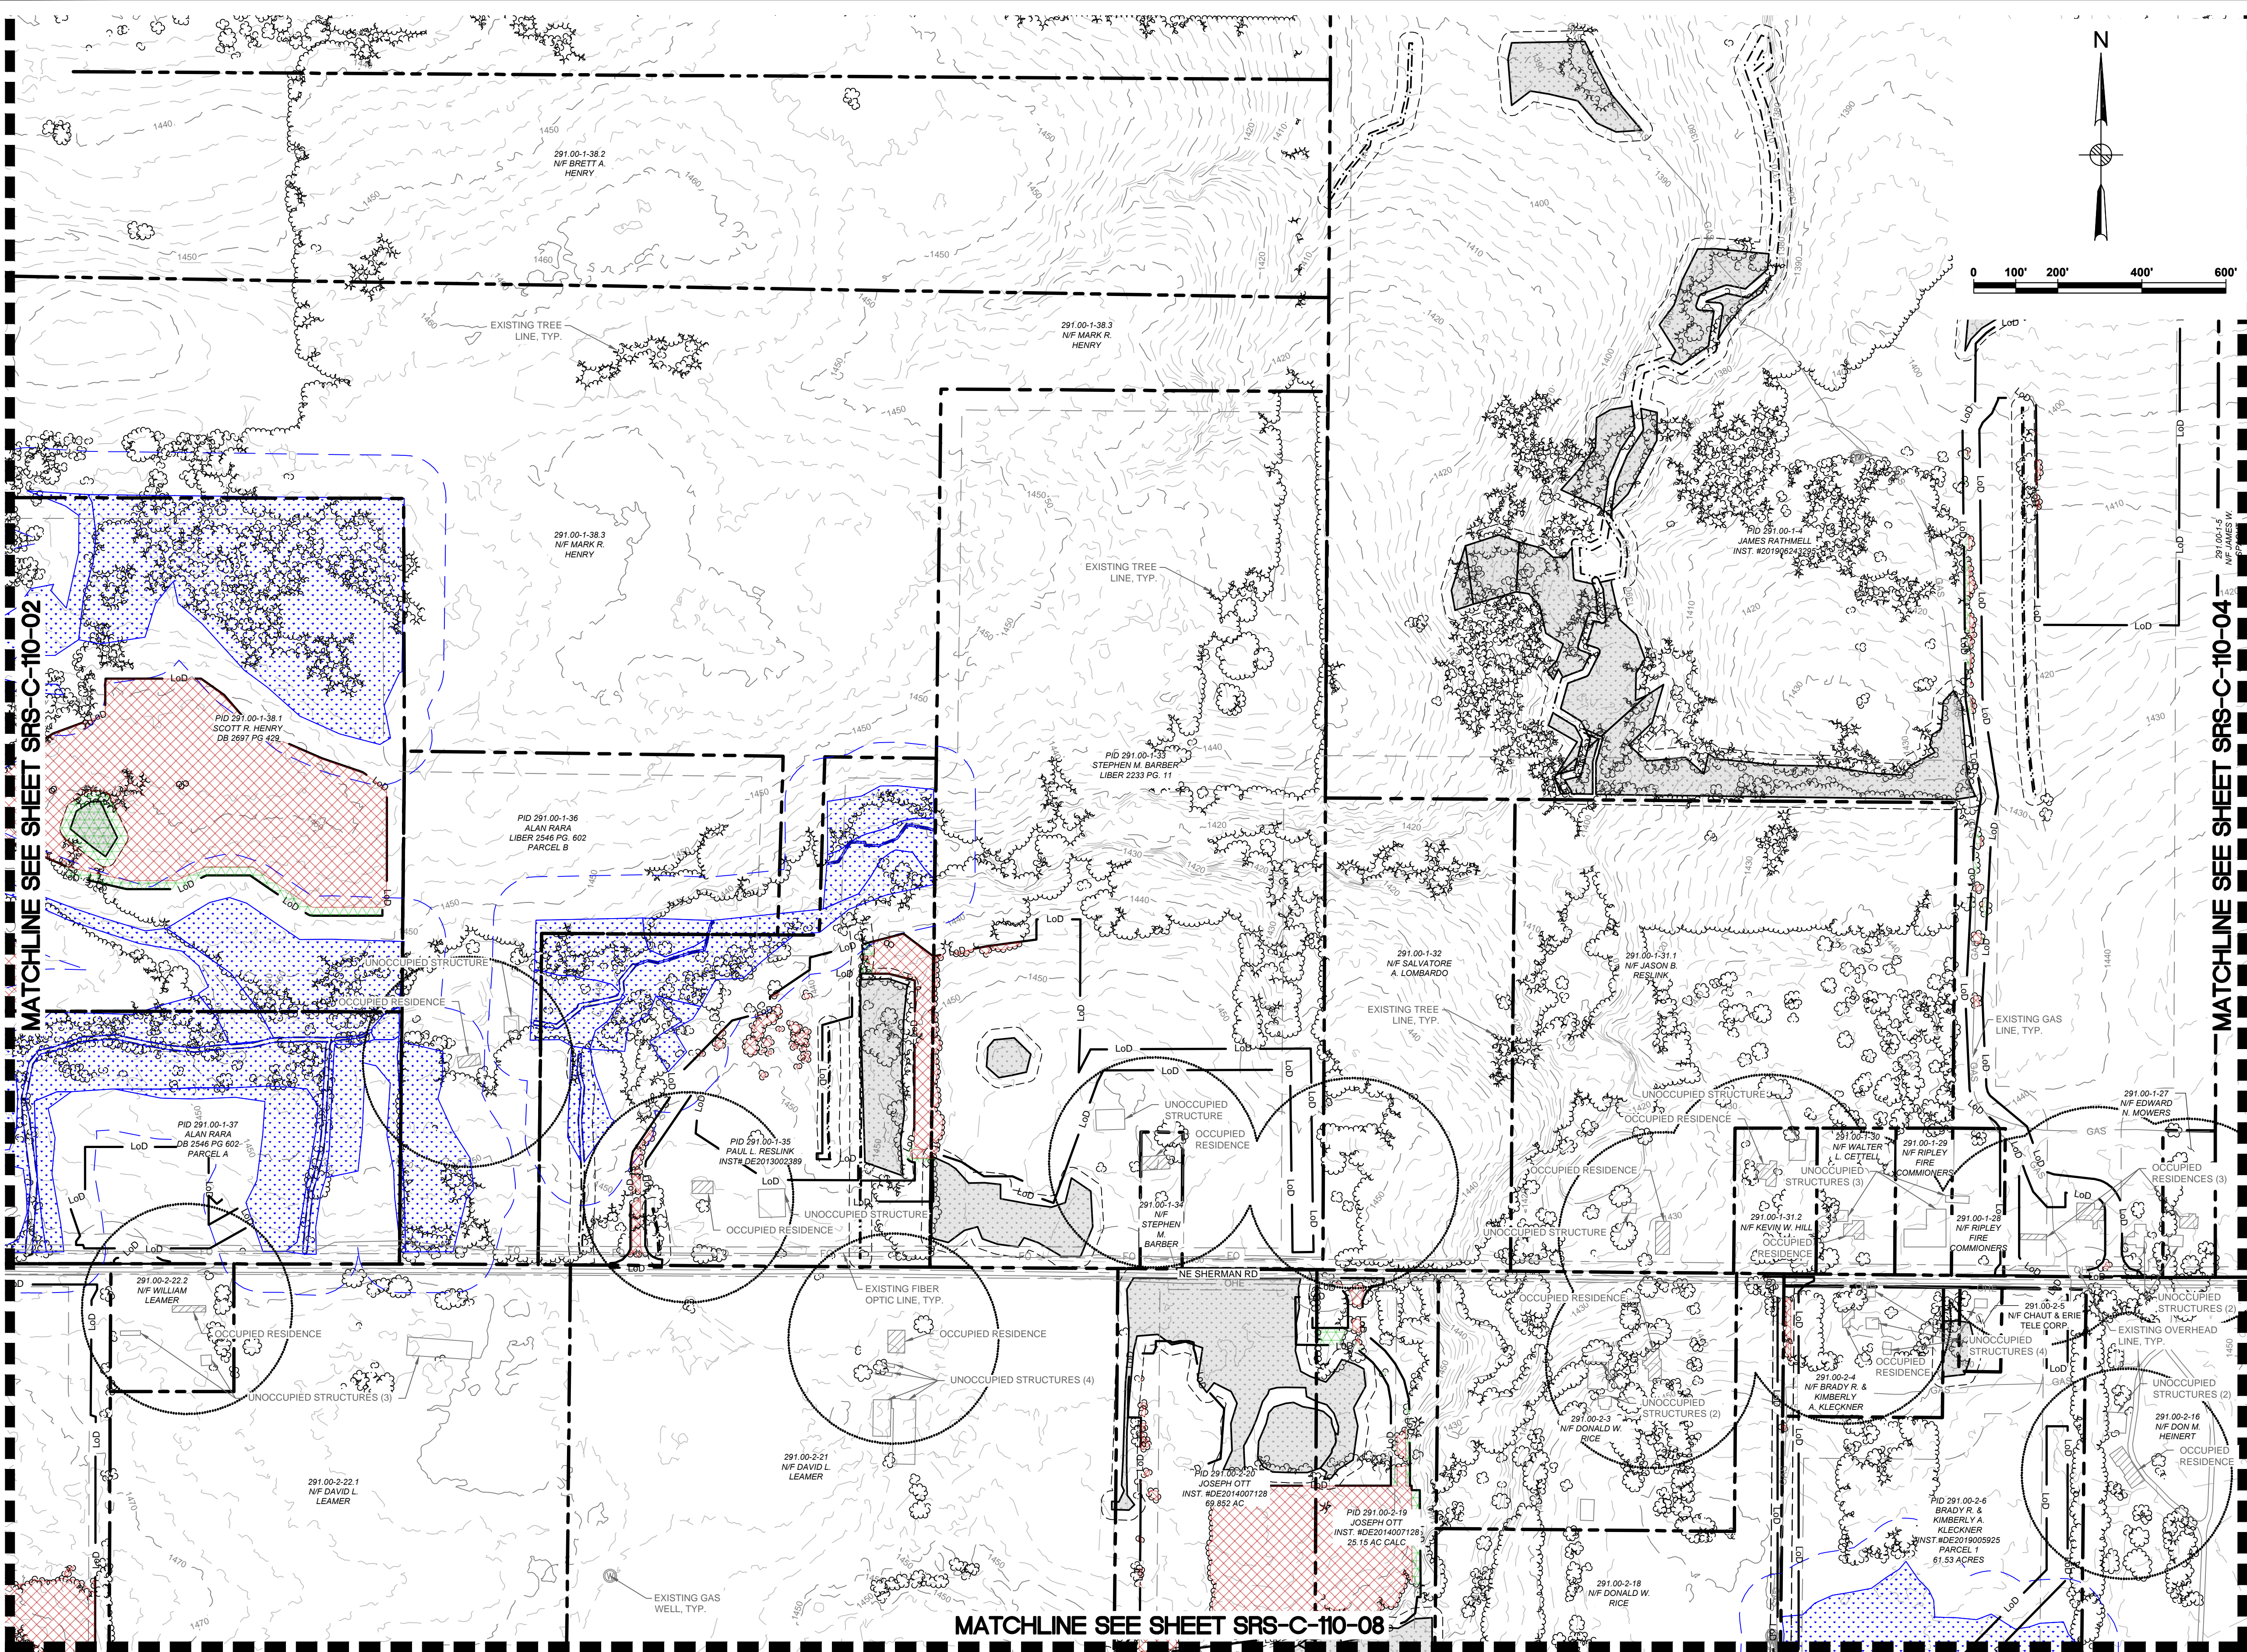
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SOUTH RIPLEY SOLAR
EXISTING CONDITIONS
& CLEARING PLAN
SITE 2
SUPPLEMENT A

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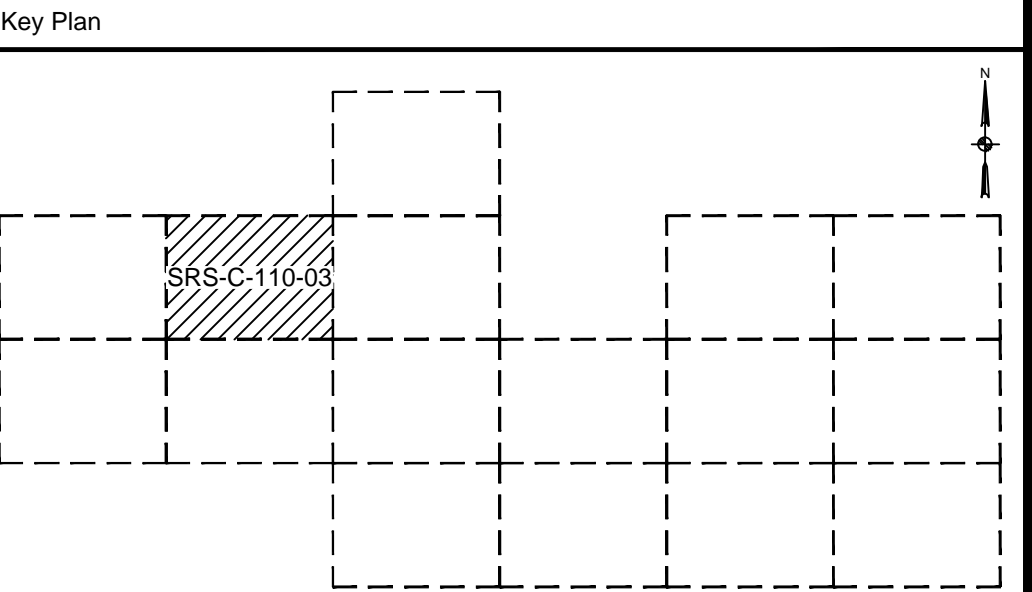
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- DRAWING SHEET MATCH LINE

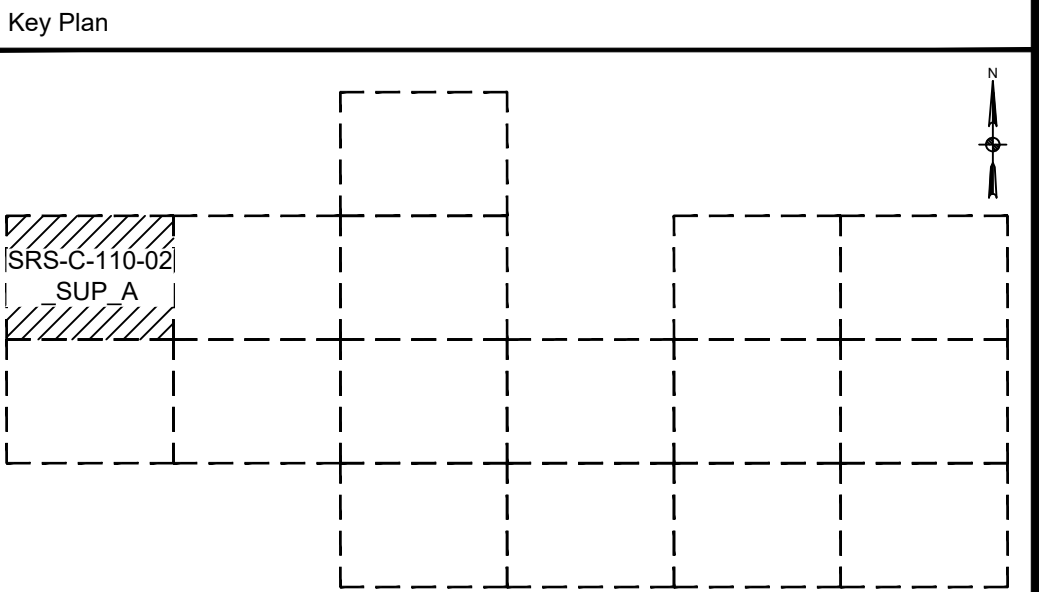

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C	07/14/2021	RCB	ISSUED FOR 94C	KW	NJM
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South Ripley
SOLAR PROJECT


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**SOUTH RIPLEY SOLAR
EXISTING CONDITIONS
& CLEARING PLAN
SITE 3**

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	Drawn	RCB	Approved	NJM
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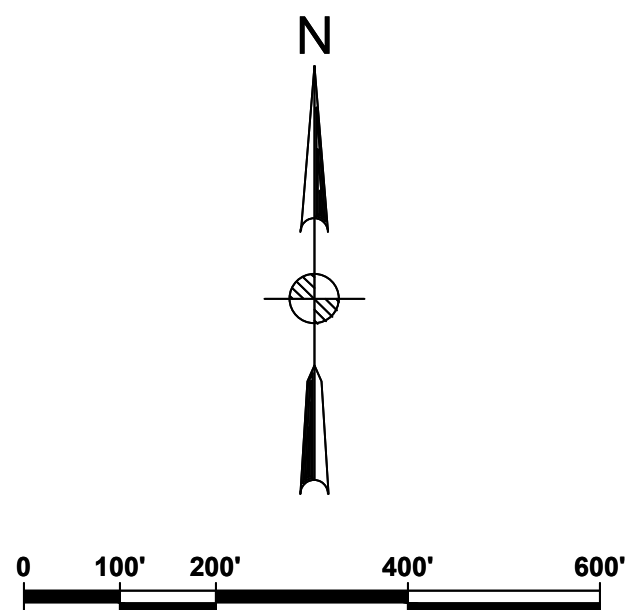
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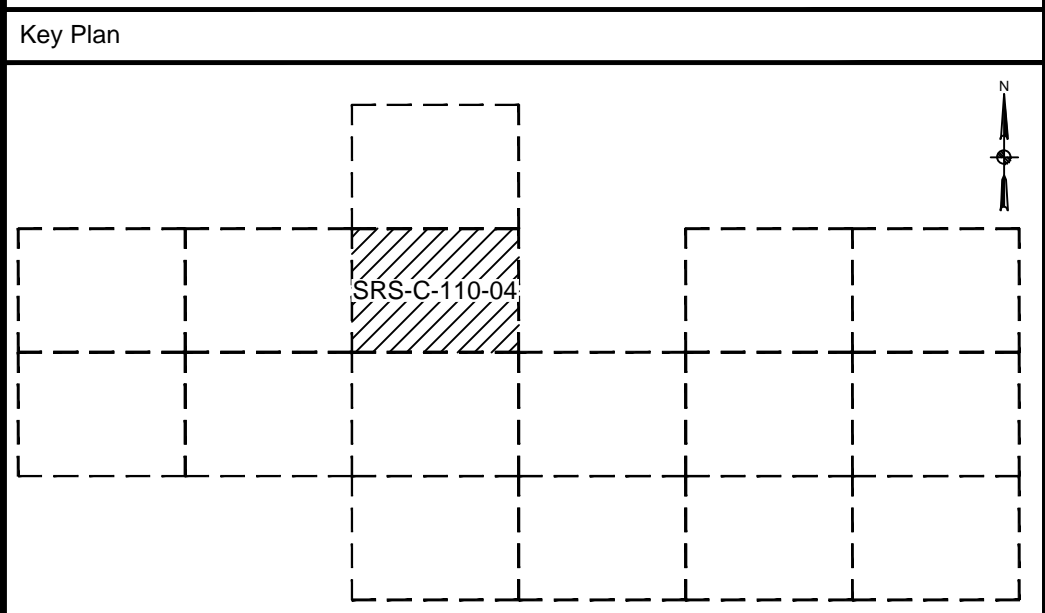
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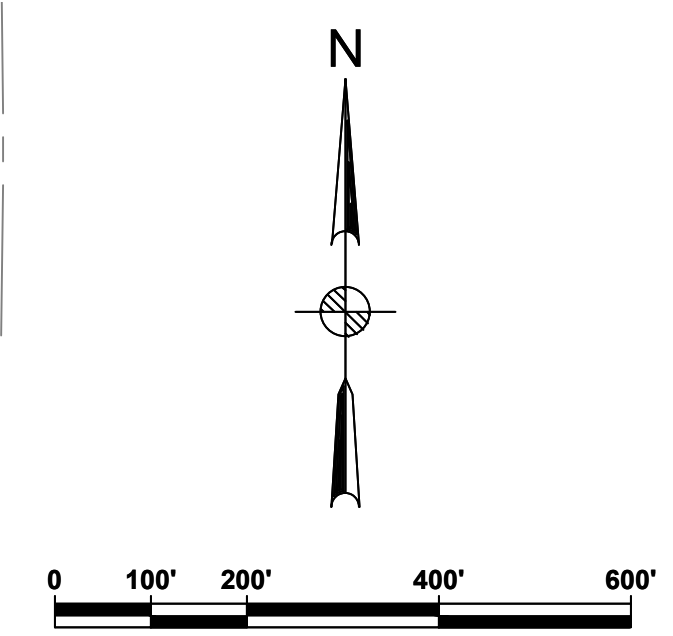
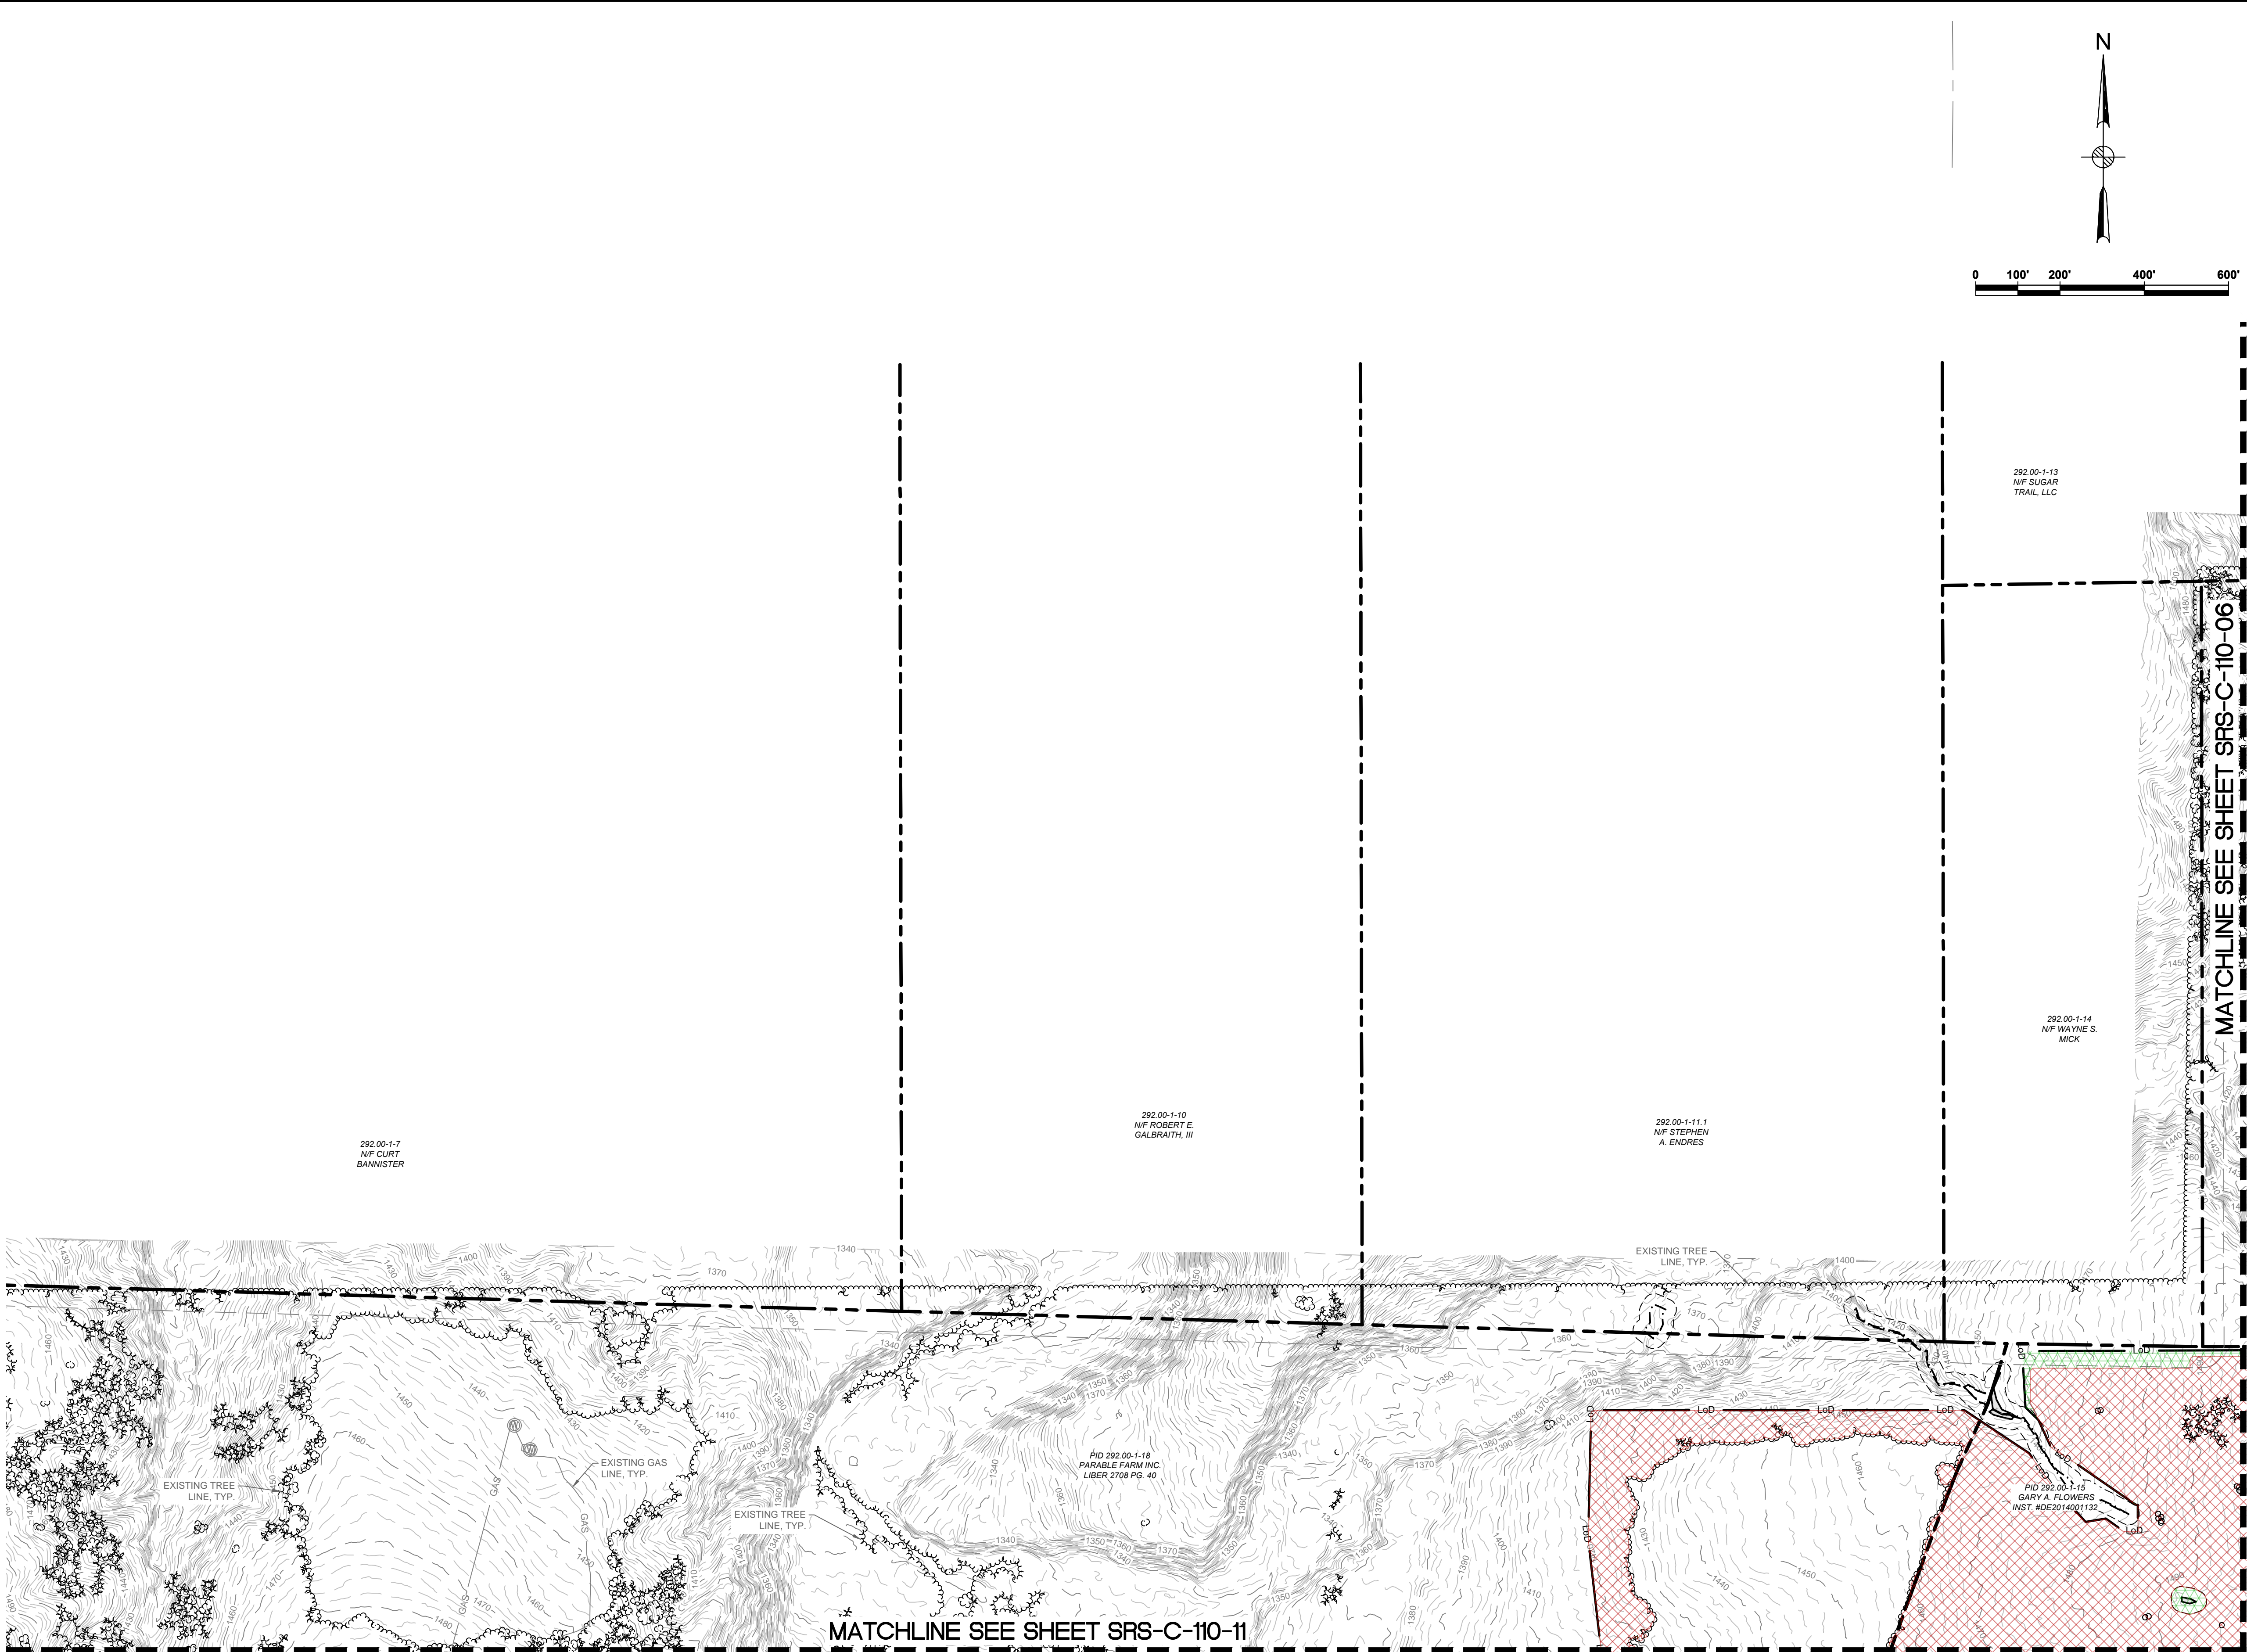
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Title
**SOUTH RIPLEY SOLAR
EXISTING CONDITIONS
& CLEARING PLAN
SITE 4**


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C	07/14/2021	RCB	ISSUED FOR 94C	KW	NJM
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A	01/29/2021	RCB	ISSUED FOR REVIEW	KW	NJM

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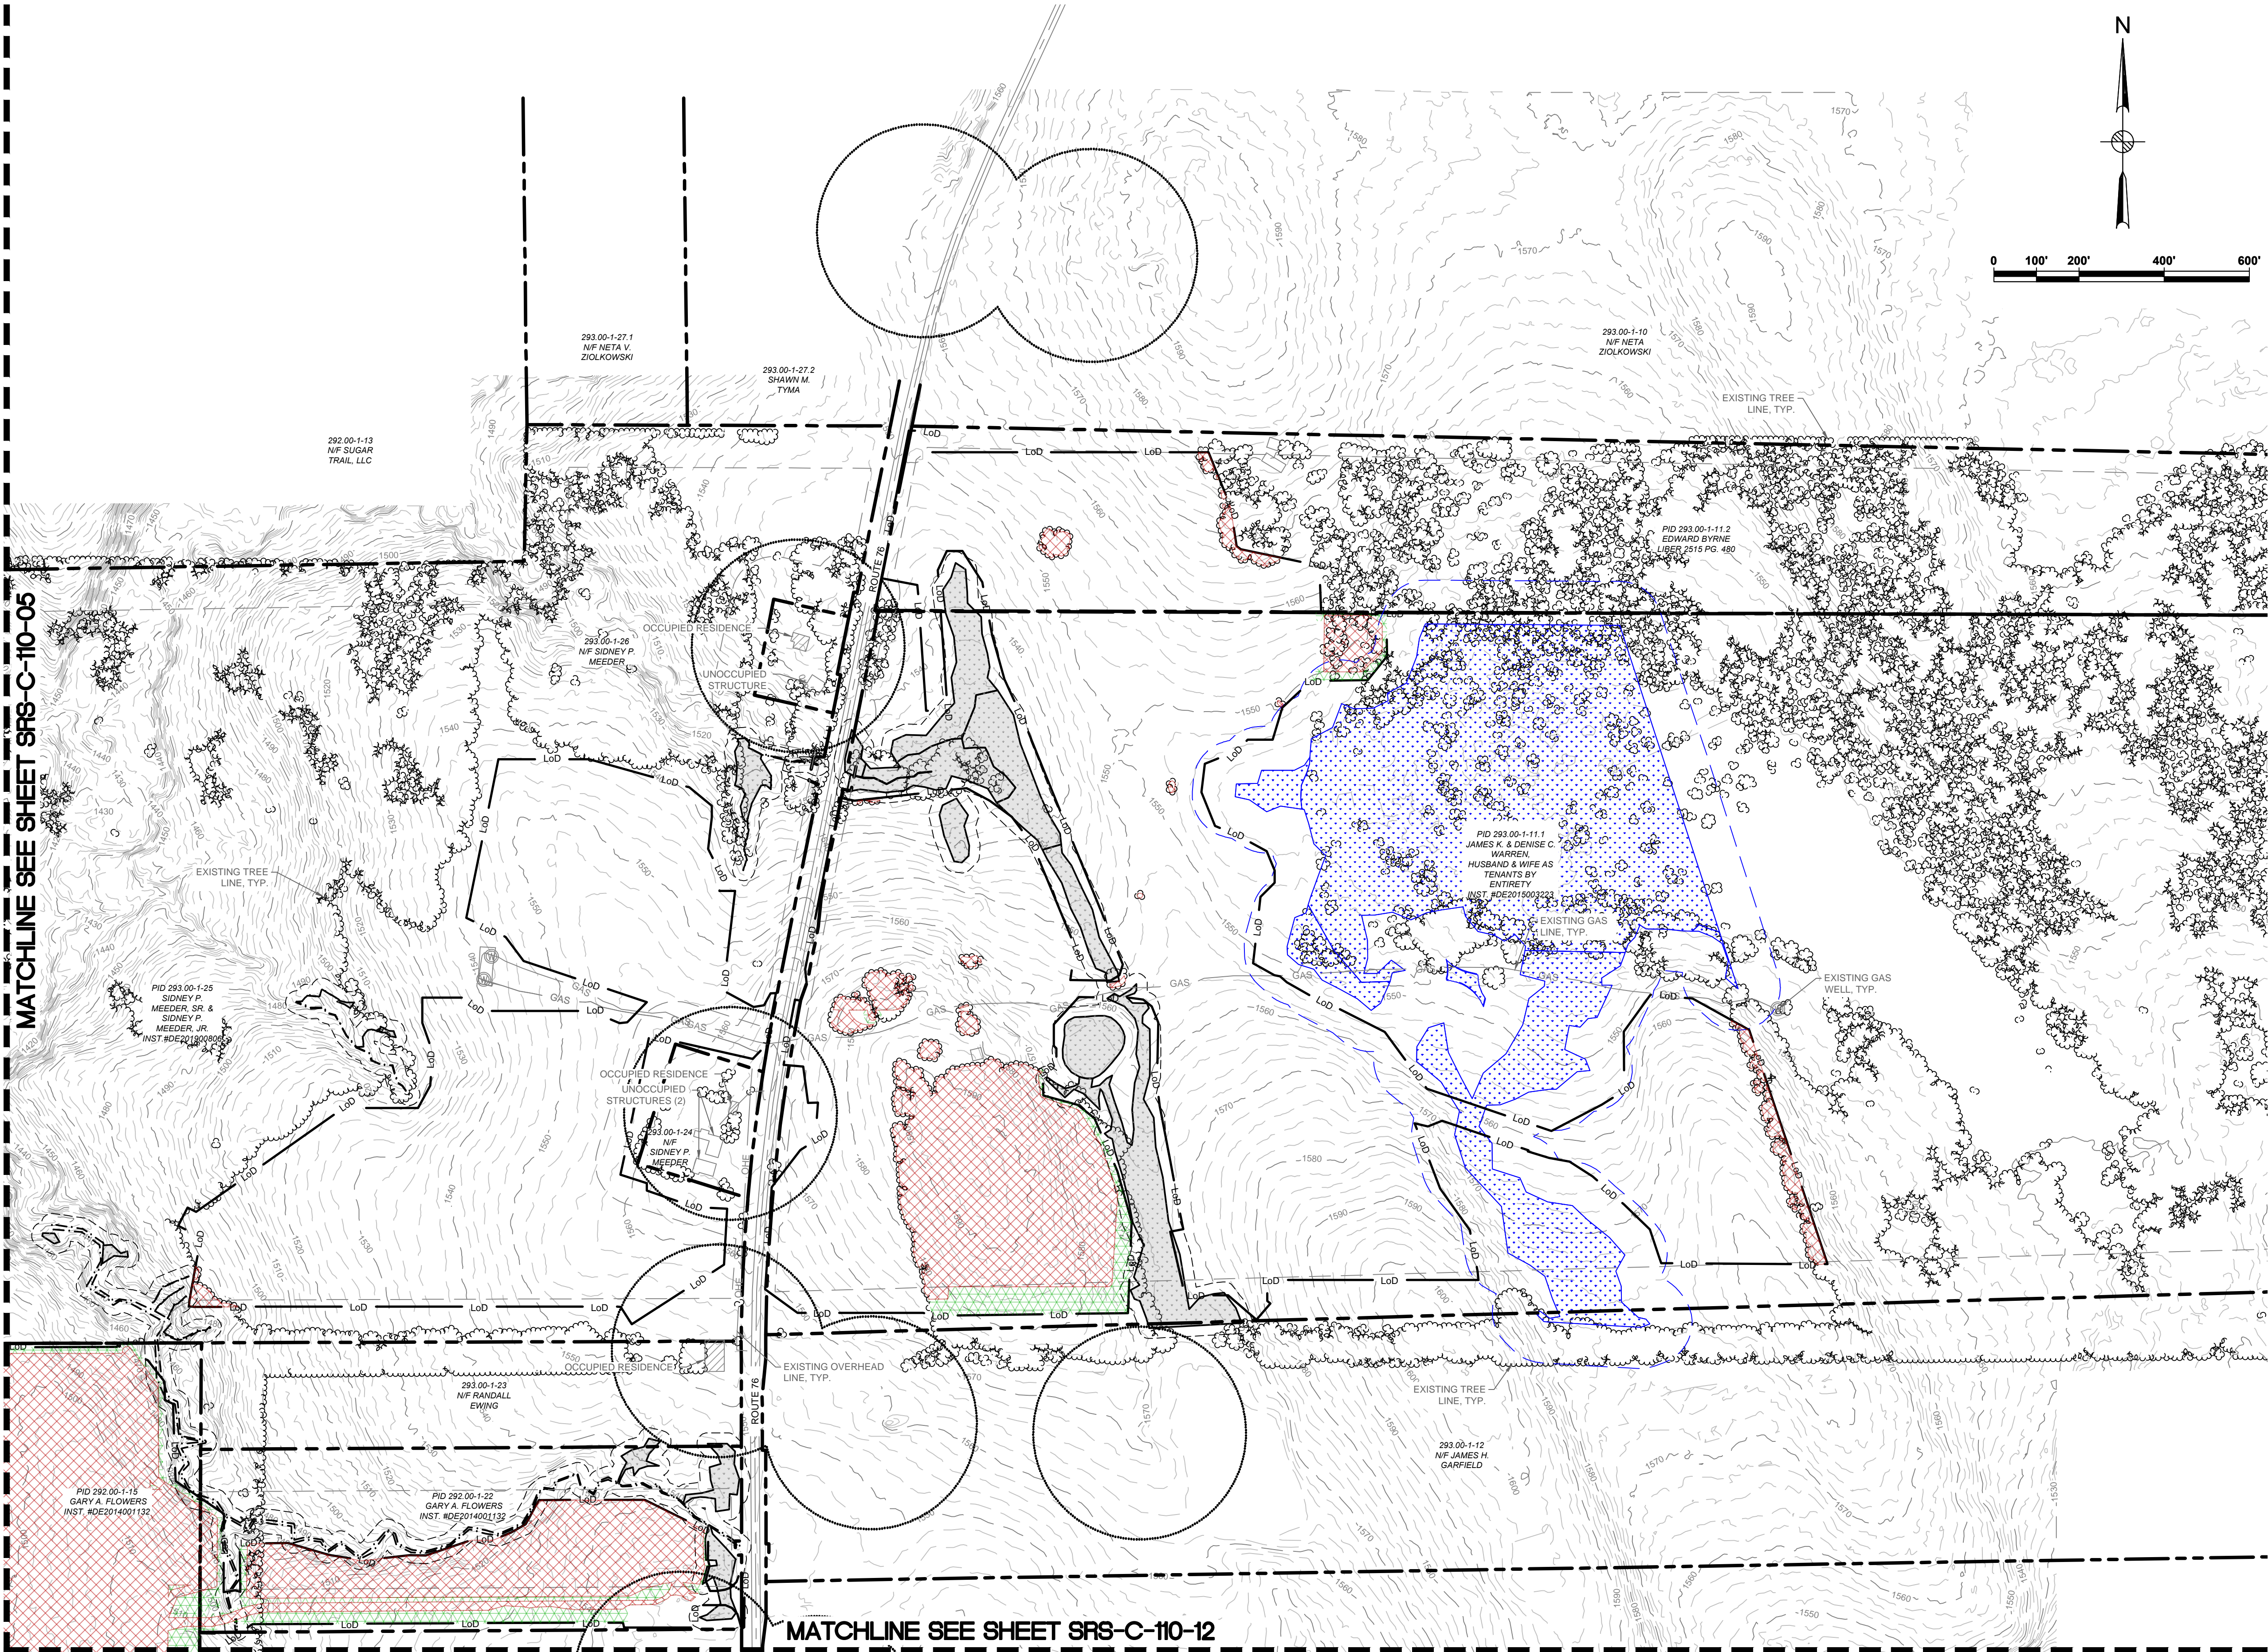
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SOUTH RIPLEY SOLAR
EXISTING CONDITIONS
& CLEARING PLAN
SITE 5

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	LIMITS OF DISTURBANCE
	DRAWING NUMBER
	DRAWING SHEET MATCH LINE

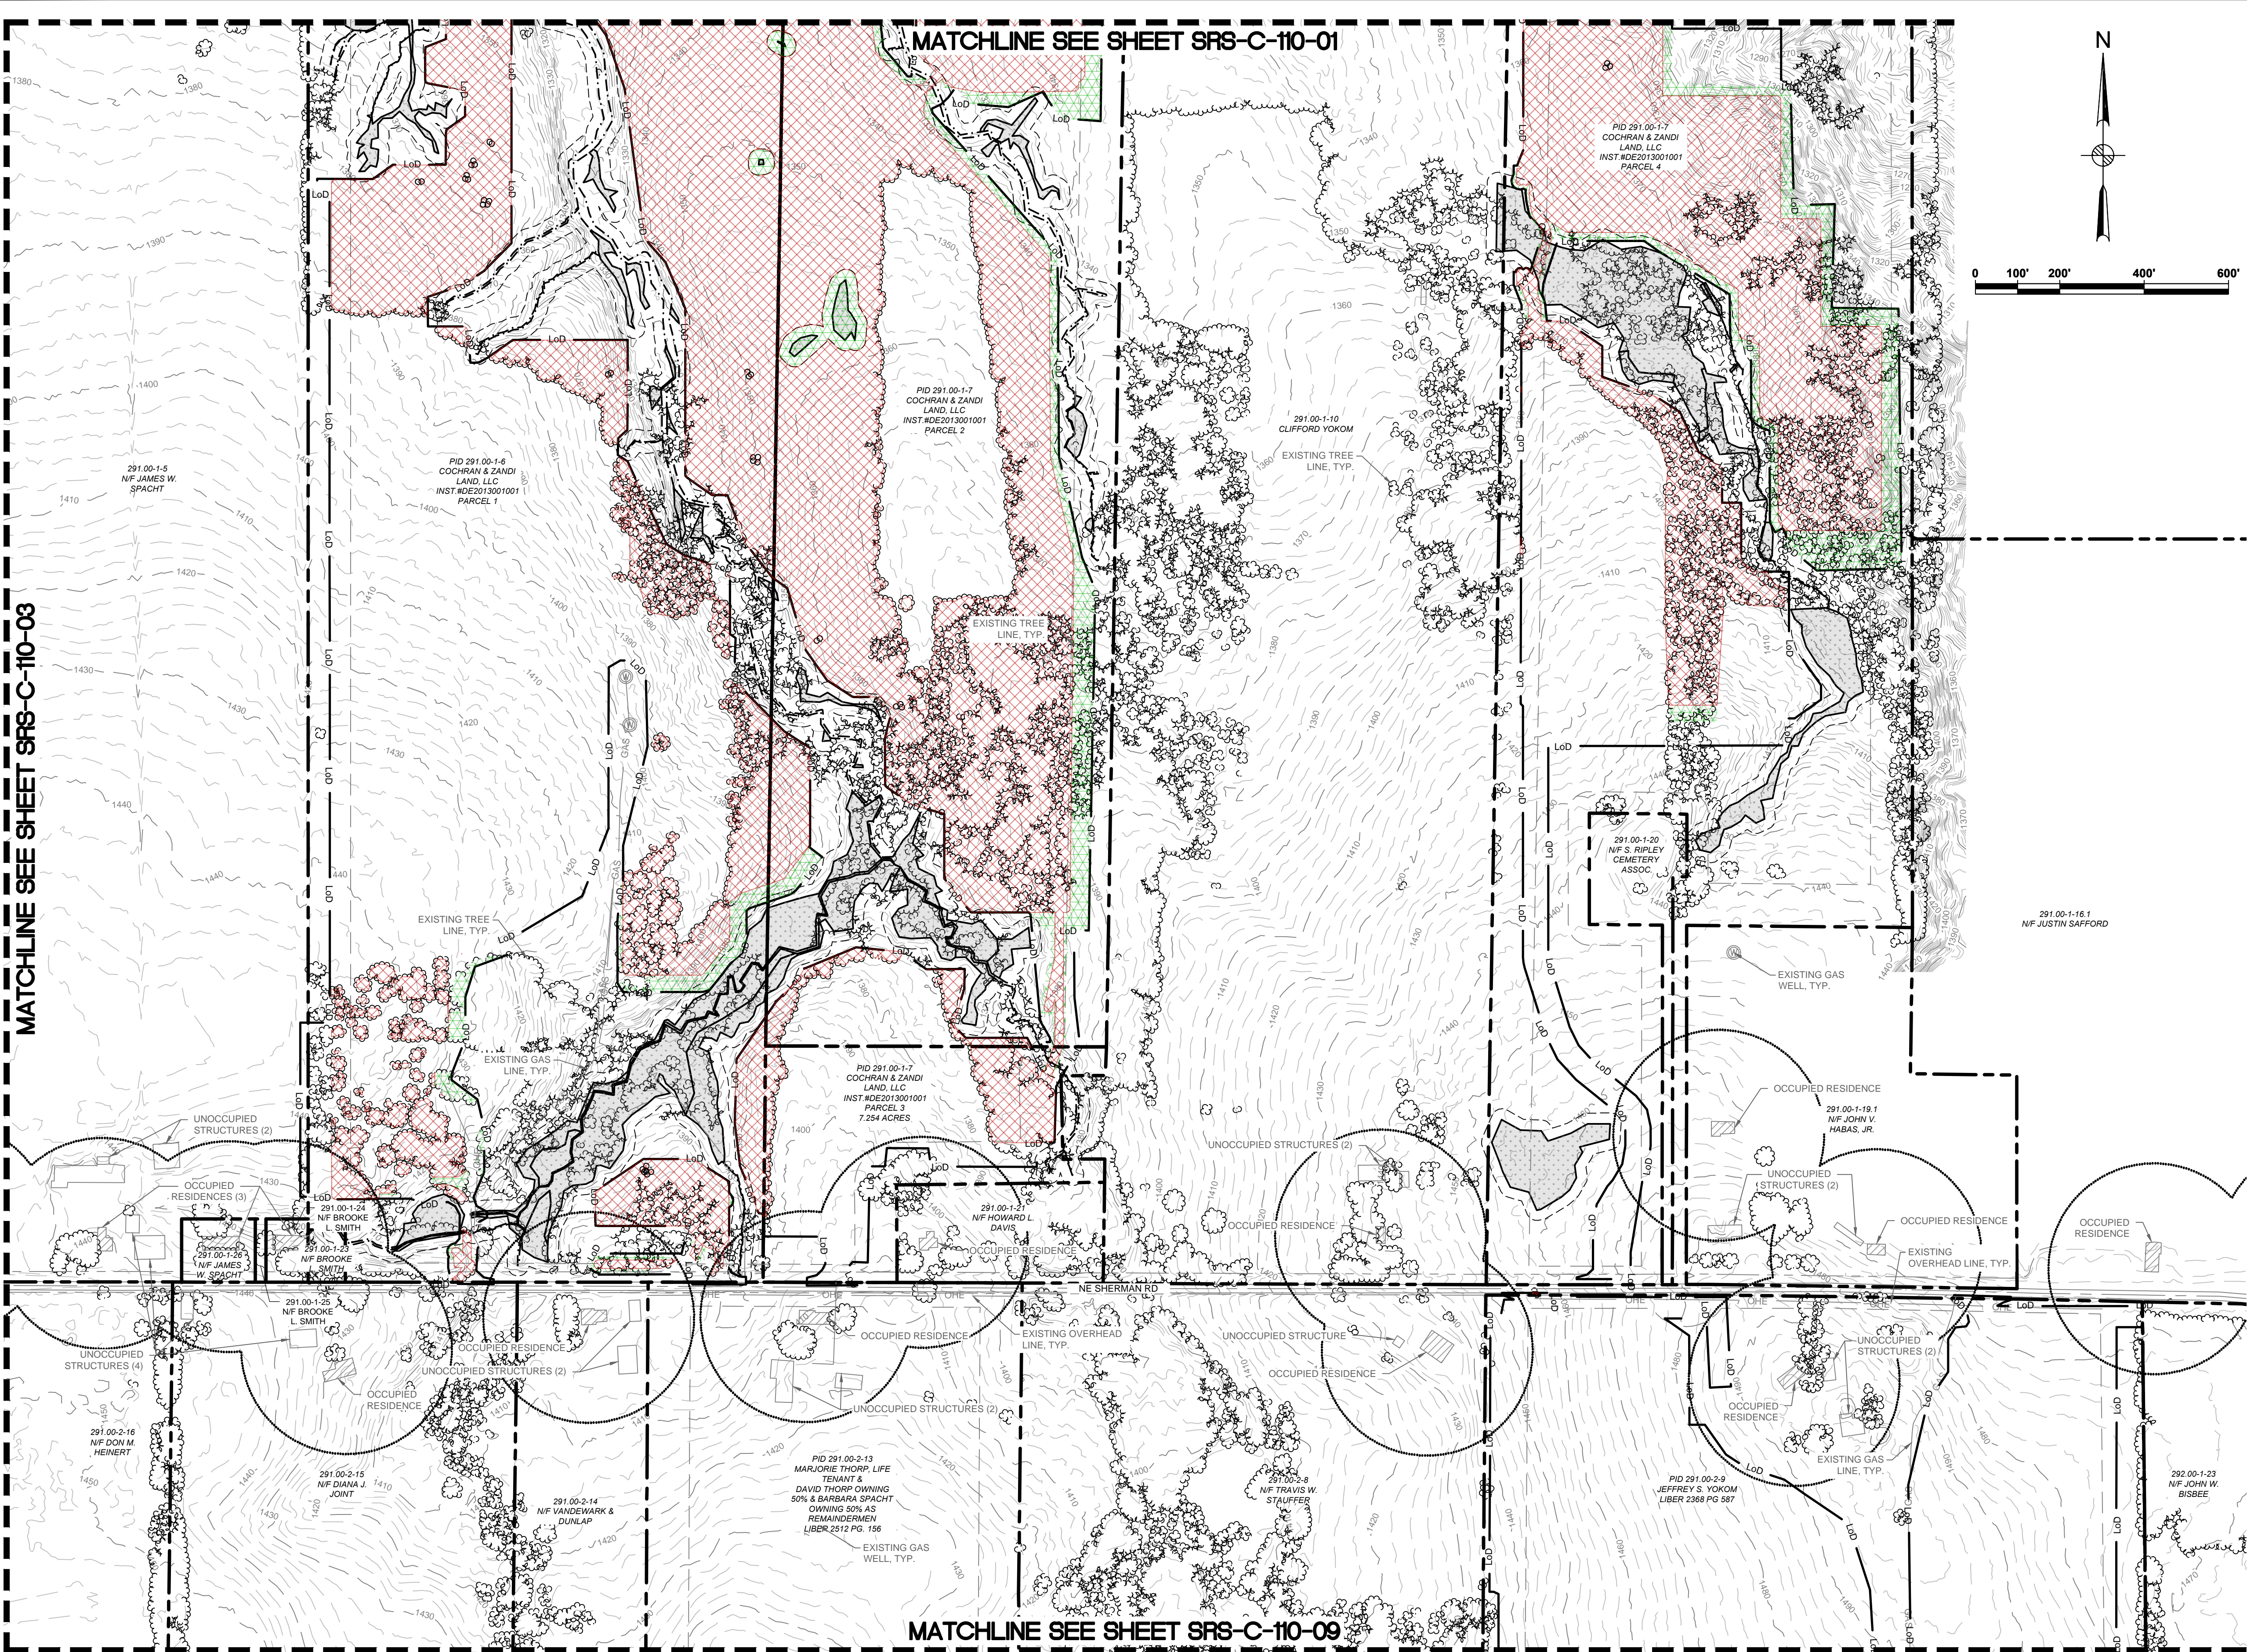Key Plan					
C	07/14/2021	RCB	ISSUED FOR 94C	KW	NJM
B	05/21/2021	RCB	ISSUED FOR REVIEW	KW	NJM
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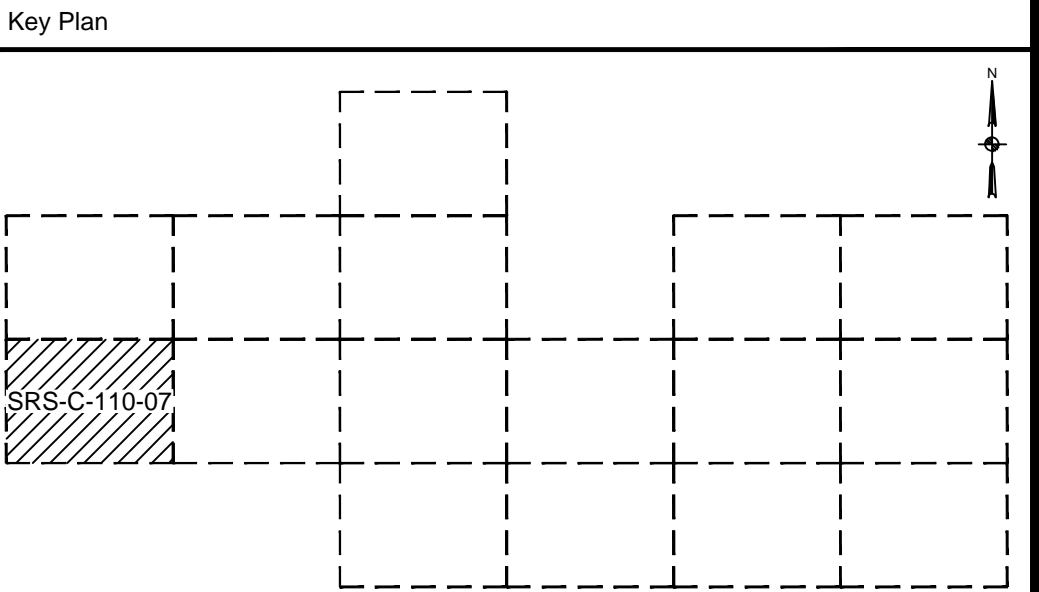
**SOUTH RIPLEY SOLAR
EXISTING CONDITIONS
& CLEARING PLAN
SITE 6**

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SRS-C-110-06

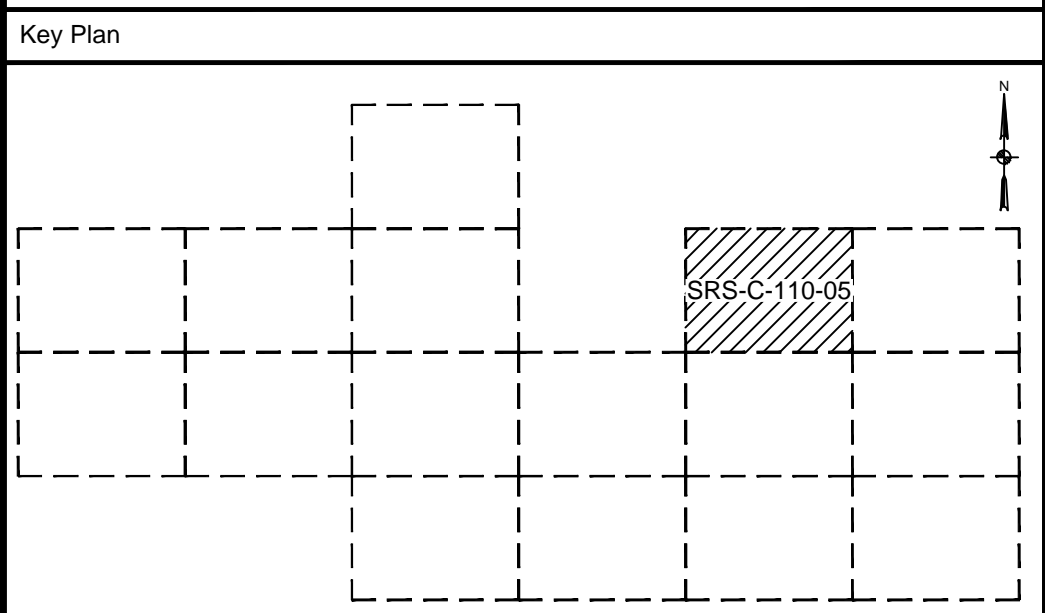

Legend	
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	PROPERTY LINE SETBACKS
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A	01/29/2021	RCB	ISSUED FOR REVIEW	KW	NJM

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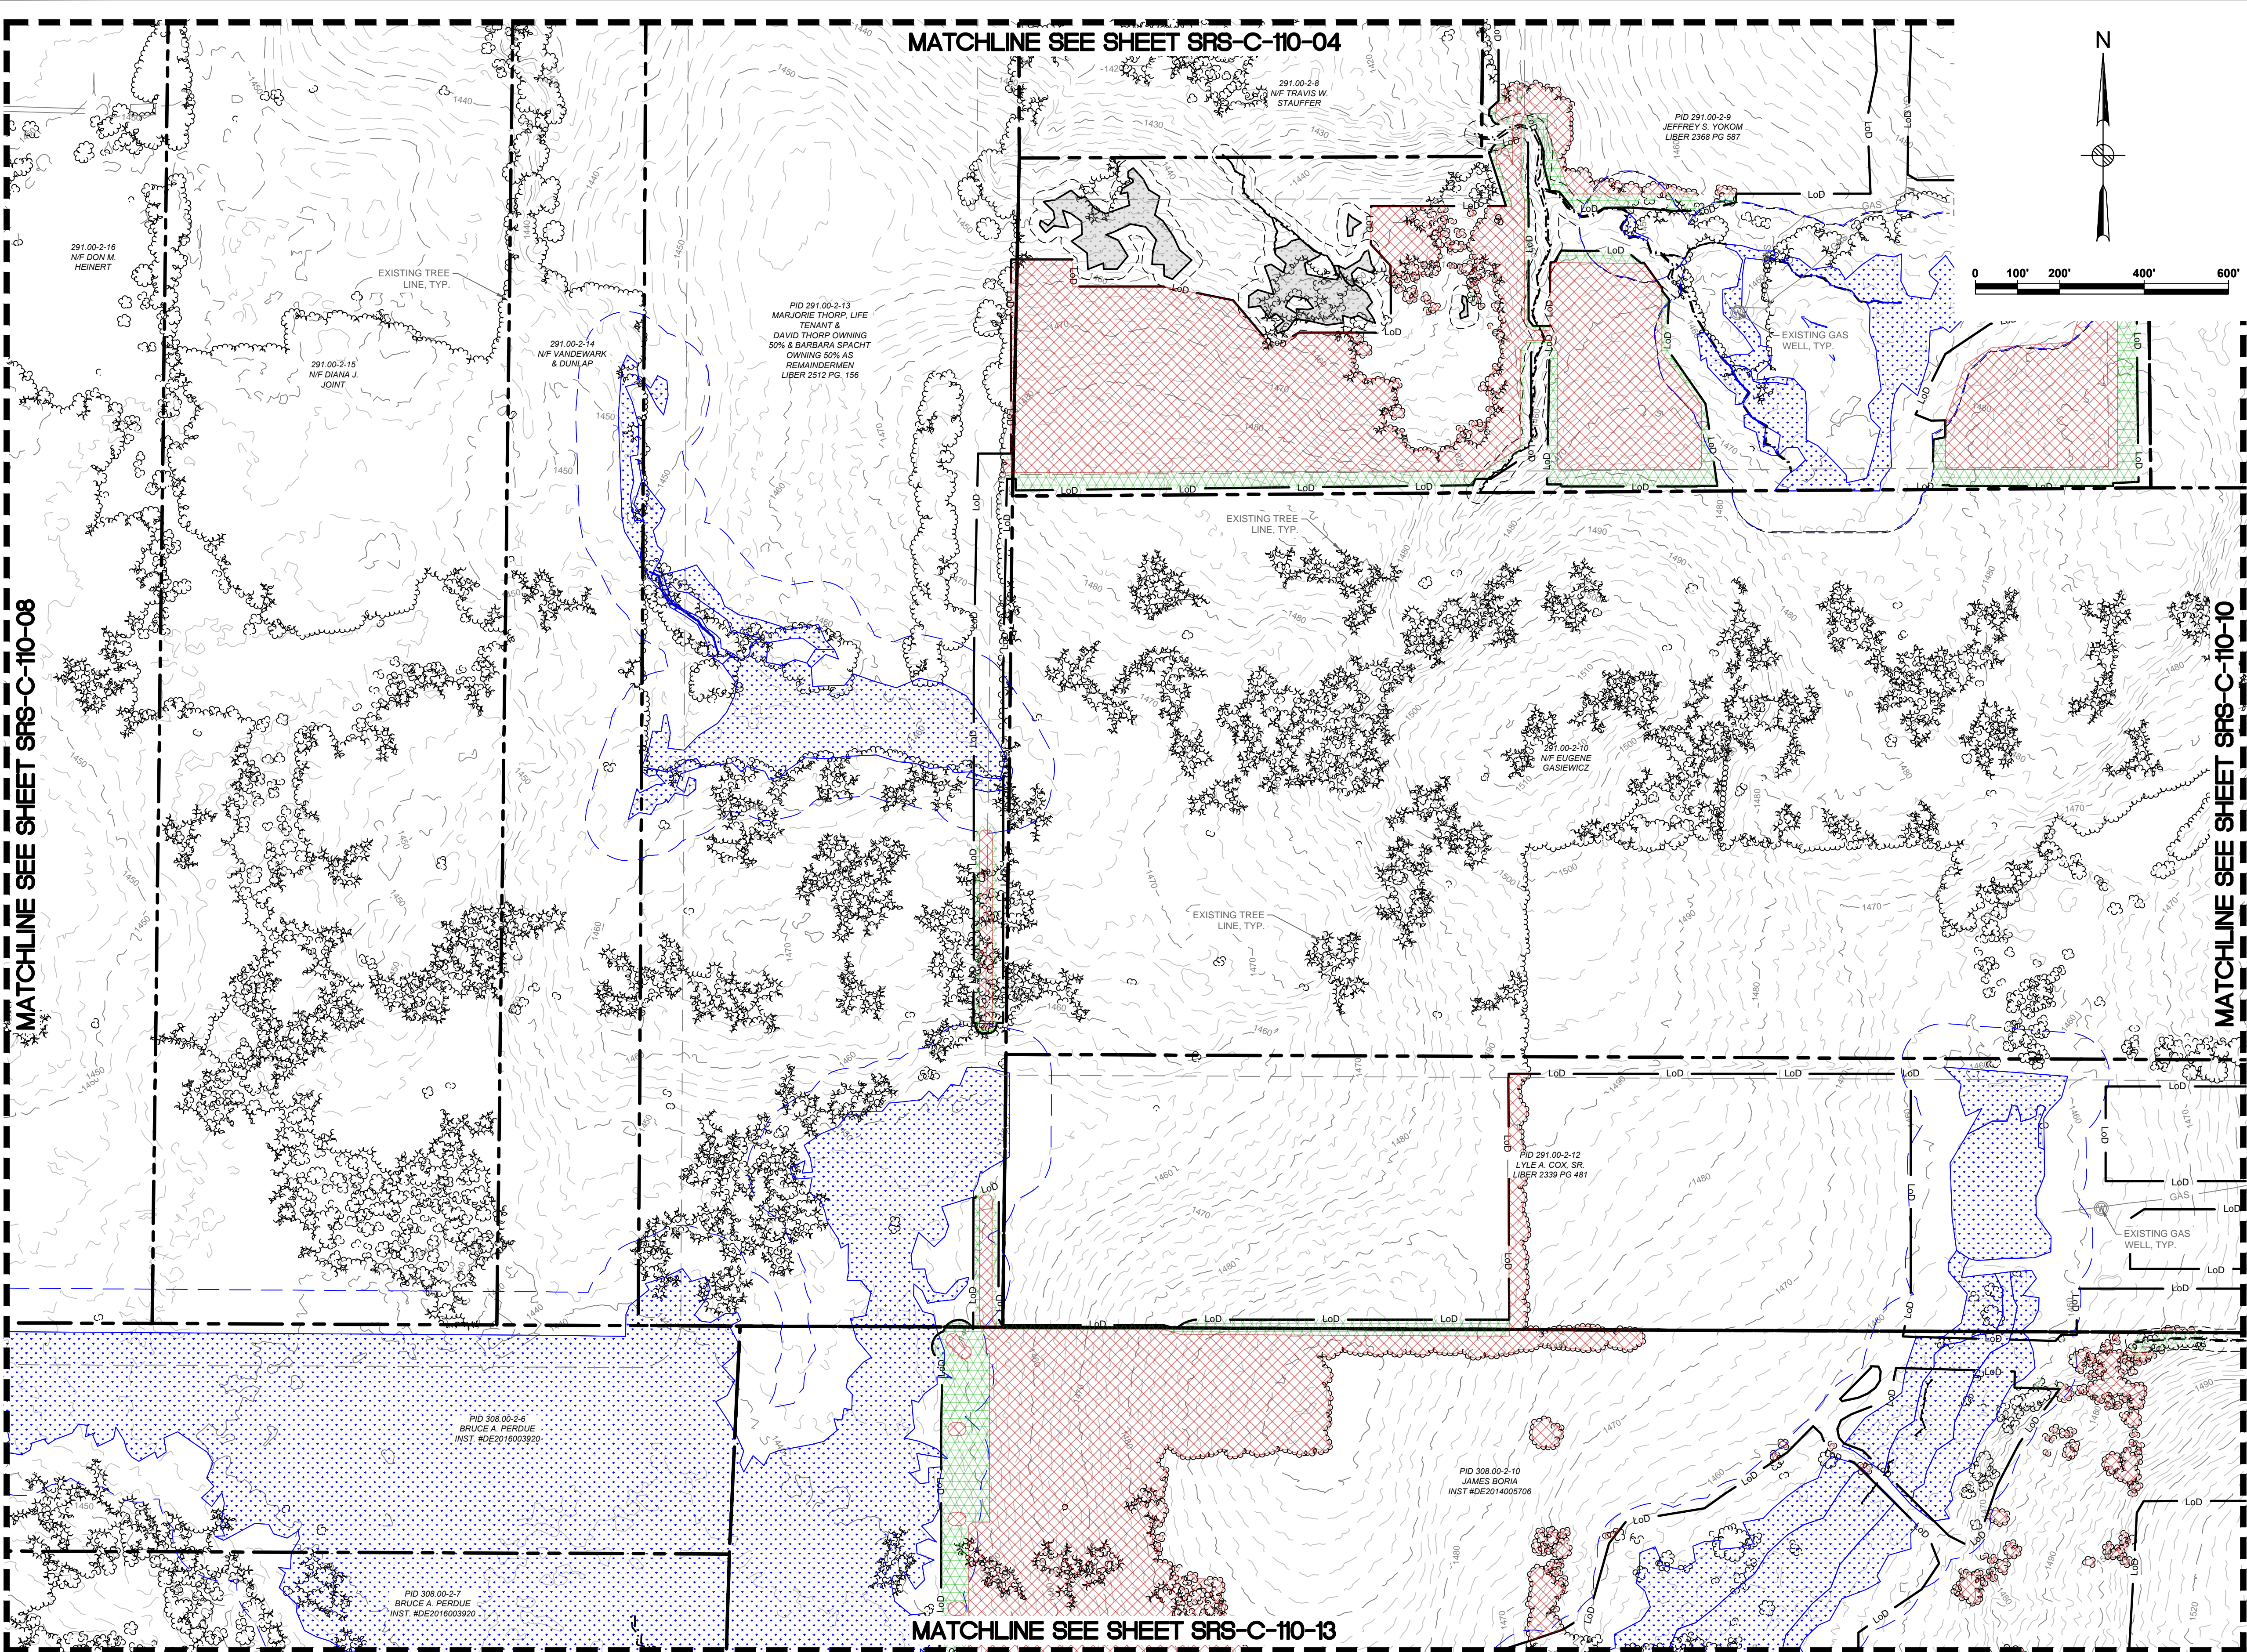
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**SOUTH RIPLEY SOLAR
EXISTING CONDITIONS
& CLEARING PLAN
SITE 7**

PRELIMINARY NOT FOR CONSTRUCTION REPLACE WITH ENGINEERS STAMP AT CONSTRUCTION AND/OR FABRICATION	Designed	MU	Eng check	KW
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	Drawing Number		07/14/2021	C


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Legend

- PROPERTY LINES
- PROPERTY LINE SETBACKS
- EXISTING MAJOR CONTOUR
- EXISTING MINOR CONTOUR
- EXISTING TREELINE
- EXISTING GAS LINE & EASEMENT
- GAS WELLS
- WETLANDS - FEDERAL
- WETLANDS - NYSDEC JURISDICTIONAL
- STREAMS - FEDERAL
- STREAMS - NYSDEC JURISDICTIONAL
- FEDERAL WETLANDS/STREAMS - SETBACK
- WETLANDS/STREAMS - SETBACK
- OCCUPIED RESIDENCES
- OCCUPIED RESIDENCE SETBACK
- TREE CLEARING ONLY
- TREE CLEARING & CLEARING/GRUBBING
- LIMITS OF DISTURBANCE
- DRAWING NUMBER
- DRAWING SHEET MATCH LINE



Rev	Date	Drawn	Description	Ch'k'd	App'd
C	07/14/2021	RCB	ISSUED FOR 94C	KW	NJM
B	05/21/2021	RCB	ISSUED FOR REVIEW	KW	NJM
A	01/29/2021	RCB	ISSUED FOR REVIEW	KW	NJM

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Client

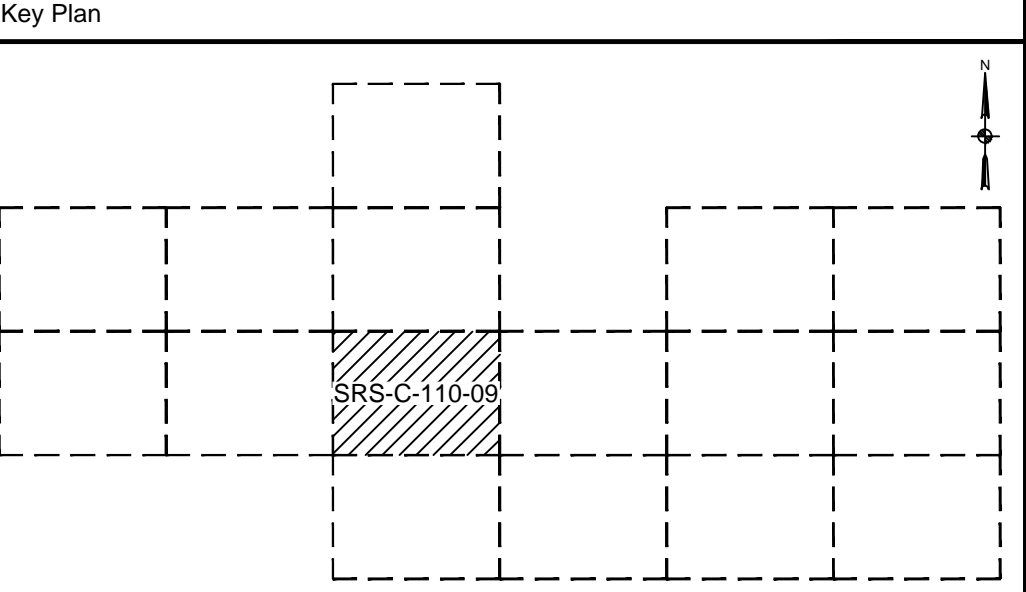South Ripley SOLAR PROJECT


Title

**SOUTH RIPLEY SOLAR
EXISTING CONDITIONS
& CLEARING PLAN
SITE 9**

PRELIMINARY NOT FOR CONSTRUCTION REPLACE WITH ENGINEERS STAMP AT CONSTRUCTION AND/OR FABRICATION	Designed	MU	Eng check	KW
	Drawn	RCB	Approved	NJM
	Dwg check		Project Mngr	
	Scale at ANSI D 1" = 200'	Date	07/14/2021	Rev C
	Drawing Number	SRS-C-110-09		

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Key Plan

The Key Plan shows a site layout with a grid of dashed lines. A shaded rectangular area is labeled 'SRS C-110-10'. A north arrow is located in the top right corner.
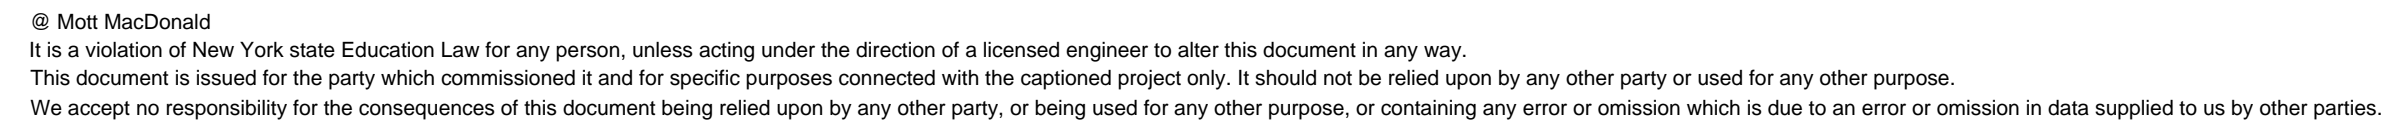
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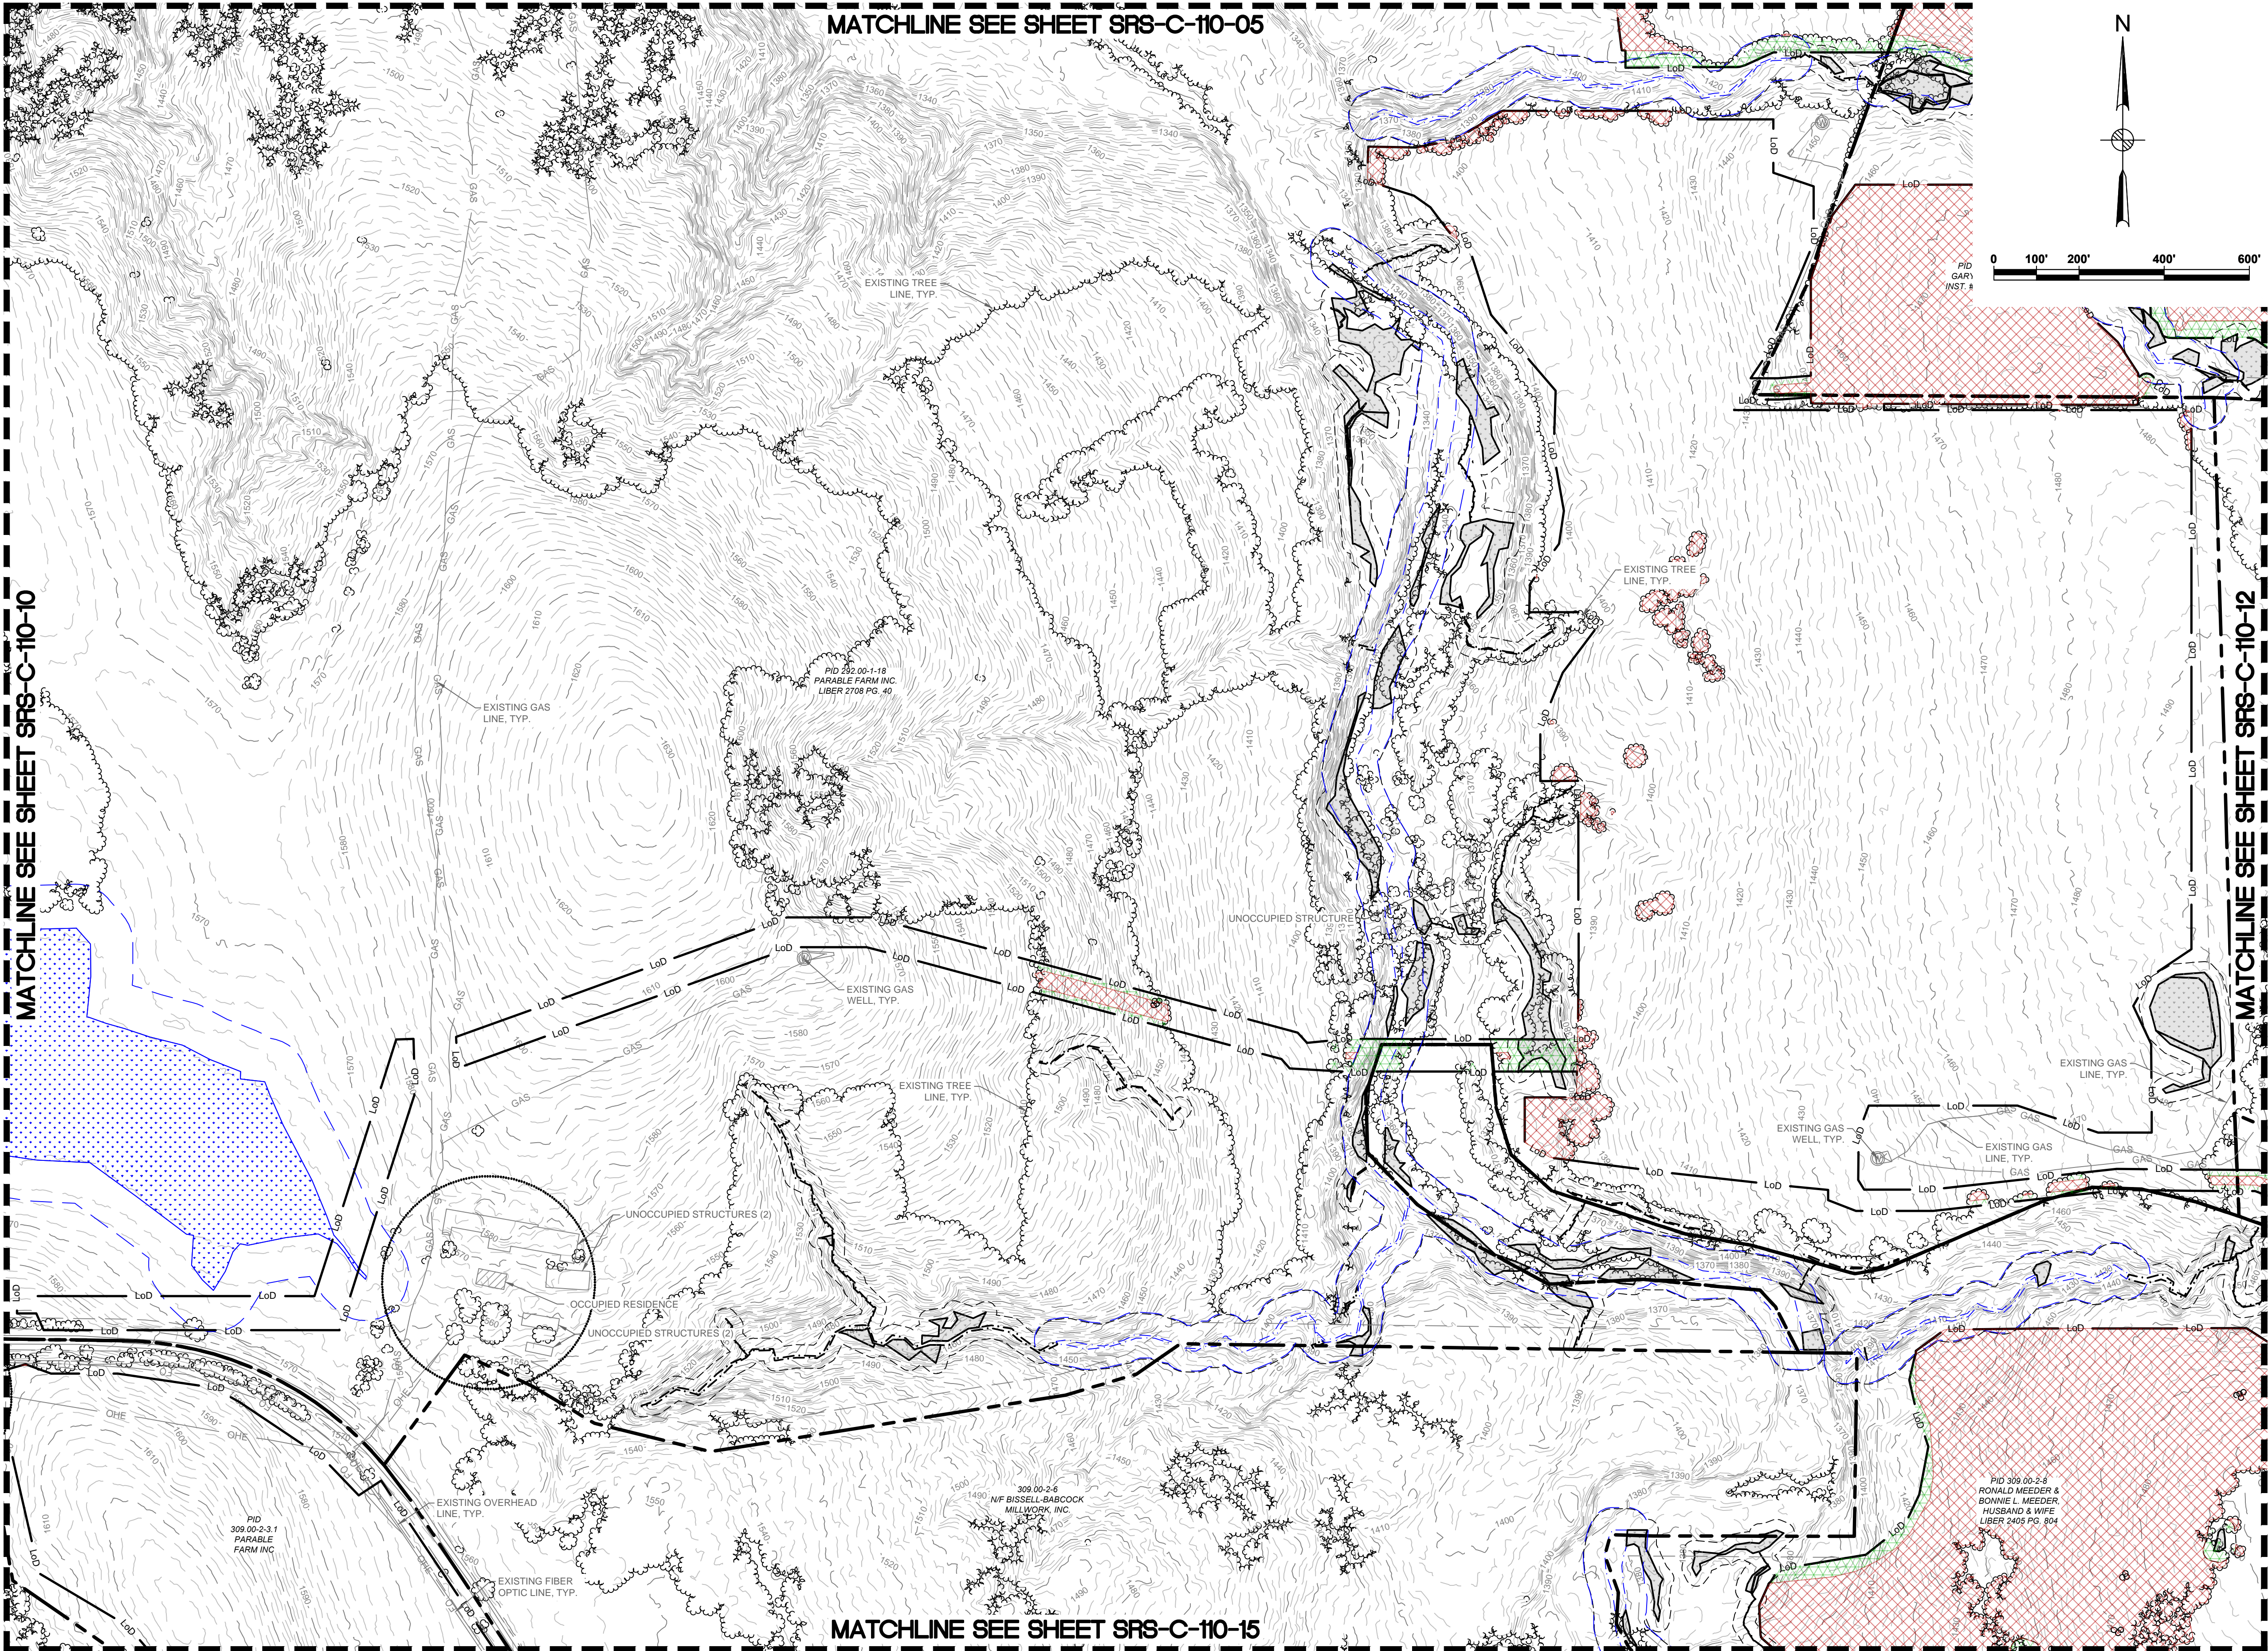
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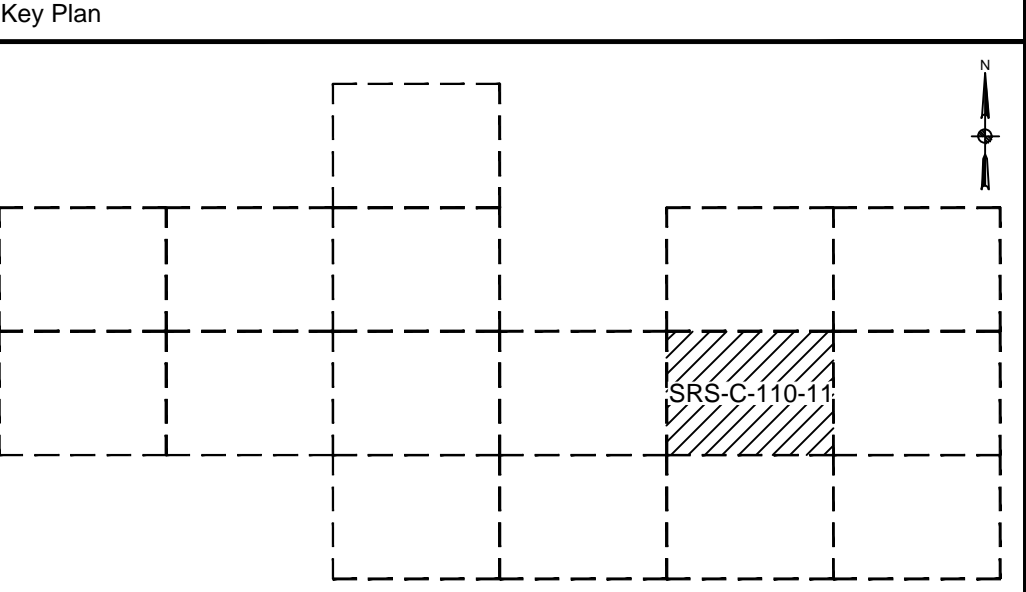


Title SOUTH RIPLEY SOLAR
EXISTING CONDITIONS
& CLEARING PLAN
SITE 10

<div>PRELIMINARY NOT FOR CONSTRUCTION</div> <div>REPLACE WITH ENGINEERS STAMP AT CONSTRUCTION AND/OR FABRICATION</div>	Designed	MU	Eng check	KW
	Drawn	RCB	Approved	NJM
	Dwg check		Project Mngr	
	Scale at ANSI D		Date	Rev
	1" = 200'		07/14/2021	C
	Drawing Number	SRS-C-110-10		



Legend	
	PROPERTY LINES
	PROPERTY LINE SETBACKS
	EXISTING MAJOR CONTOUR
	EXISTING MINOR CONTOUR
	EXISTING TREELINE
	EXISTING GAS LINE & EASEMENT
	GAS WELLS
	WETLANDS - FEDERAL
	WETLANDS - NYSDEC JURISDICTIONAL
	STREAMS - FEDERAL
	STREAMS - NYSDEC JURISDICTIONAL
	FEDERAL WETLANDS/STREAMS - SETBACK
	WETLANDS/STREAMS - SETBACK
	OCCUPIED RESIDENCES
	OCCUPIED RESIDENCE SETBACK
	TREE CLEARING ONLY
	TREE CLEARING & CLEARING/GRUBBING
	LIMITS OF DISTURBANCE
	DRAWING NUMBER
	DRAWING SHEET MATCH LINE



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C	07/14/2021	RCB	ISSUED FOR 94C	KW	NJM
B	05/21/2021	RCB	ISSUED FOR REVIEW	KW	NJM
A	01/29/2021	RCB	ISSUED FOR REVIEW	KW	NJM

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Title
**SOUTH RIPLEY SOLAR
EXISTING CONDITIONS
& CLEARING PLAN
SITE 11**

PRELIMINARY NOT FOR CONSTRUCTION REPLACE WITH ENGINEERS STAMP AT CONSTRUCTION AND/OR FABRICATION	Designed	MU	Eng check	KW
	Drawn	RCB	Approved	NJM
	Dwg check		Project Mngr	
	Scale at ANSI D 1" = 200'		Date	Rev
	Drawing Number	SRS-C-110-11		

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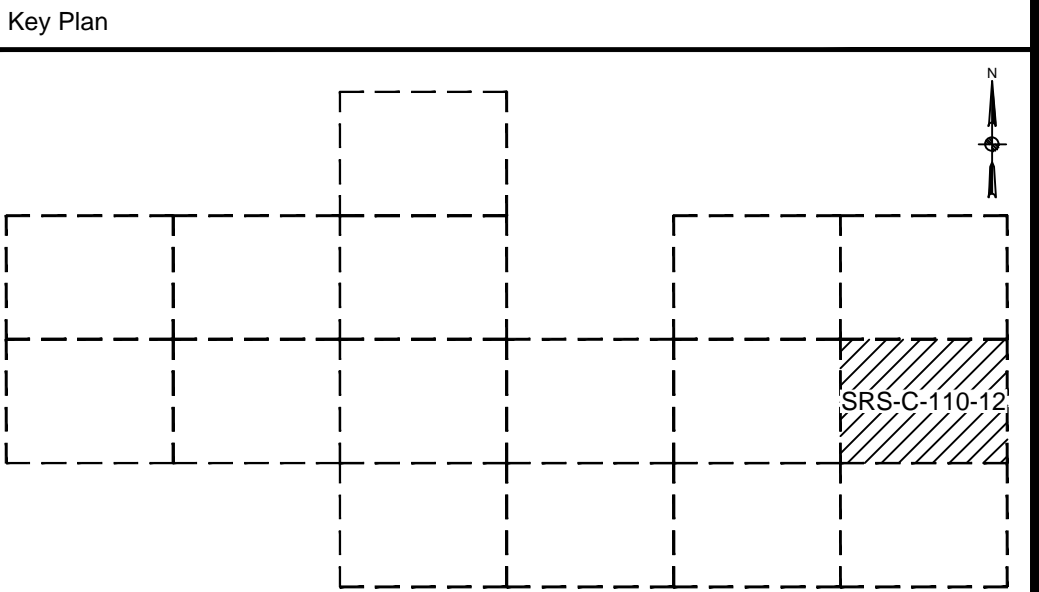
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Legend	
	PROPERTY LINES
	PROPERTY LINE SETBACKS
	EXISTING MAJOR CONTOUR
	EXISTING MINOR CONTOUR
	EXISTING TREELINE
	EXISTING GAS LINE & EASEMENT
	GAS WELLS
	WETLANDS - FEDERAL
	WETLANDS - NYSDEC JURISDICTIONAL
	STREAMS - FEDERAL
	STREAMS - NYSDEC JURISDICTIONAL
	FEDERAL WETLANDS/STREAMS - SETBACK
	WETLANDS/STREAMS - SETBACK
	OCCUPIED RESIDENCES
	OCCUPIED RESIDENCE SETBACK
	TREE CLEARING ONLY
	TREE CLEARING & CLEARING/GRUBBING
	LIMITS OF DISTURBANCE
	DRAWING NUMBER
	DRAWING NUMBER
	DRAWING SHEET MATCH LINE




Rev	Date	Drawn	Description	Ch'k'd	App'd
C	07/14/2021	RCB	ISSUED FOR 94C	KW	NJM
B	05/21/2021	RCB	ISSUED FOR REVIEW	KW	NJM
A	01/29/2021	RCB	ISSUED FOR REVIEW	KW	NJM

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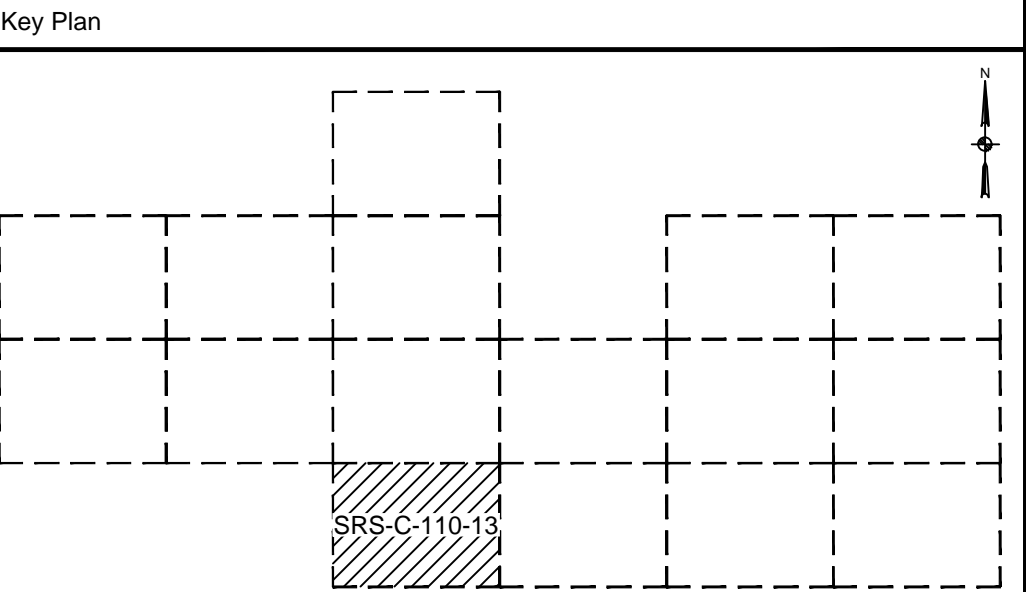
Title
**SOUTH RIPLEY SOLAR
EXISTING CONDITIONS
& CLEARING PLAN
SITE 12**

PRELIMINARY NOT FOR CONSTRUCTION REPLACE WITH ENGINEERS STAMP AT CONSTRUCTION AND/OR FABRICATION	Designed	MU	Eng check	KW
	Drawn	RCB	Approved	NJM
	Dwg check		Project Mngr	
	Scale at ANSI D 1" = 200'		Date	Rev
	Drawing Number	SRS-C-110-12		



Legend

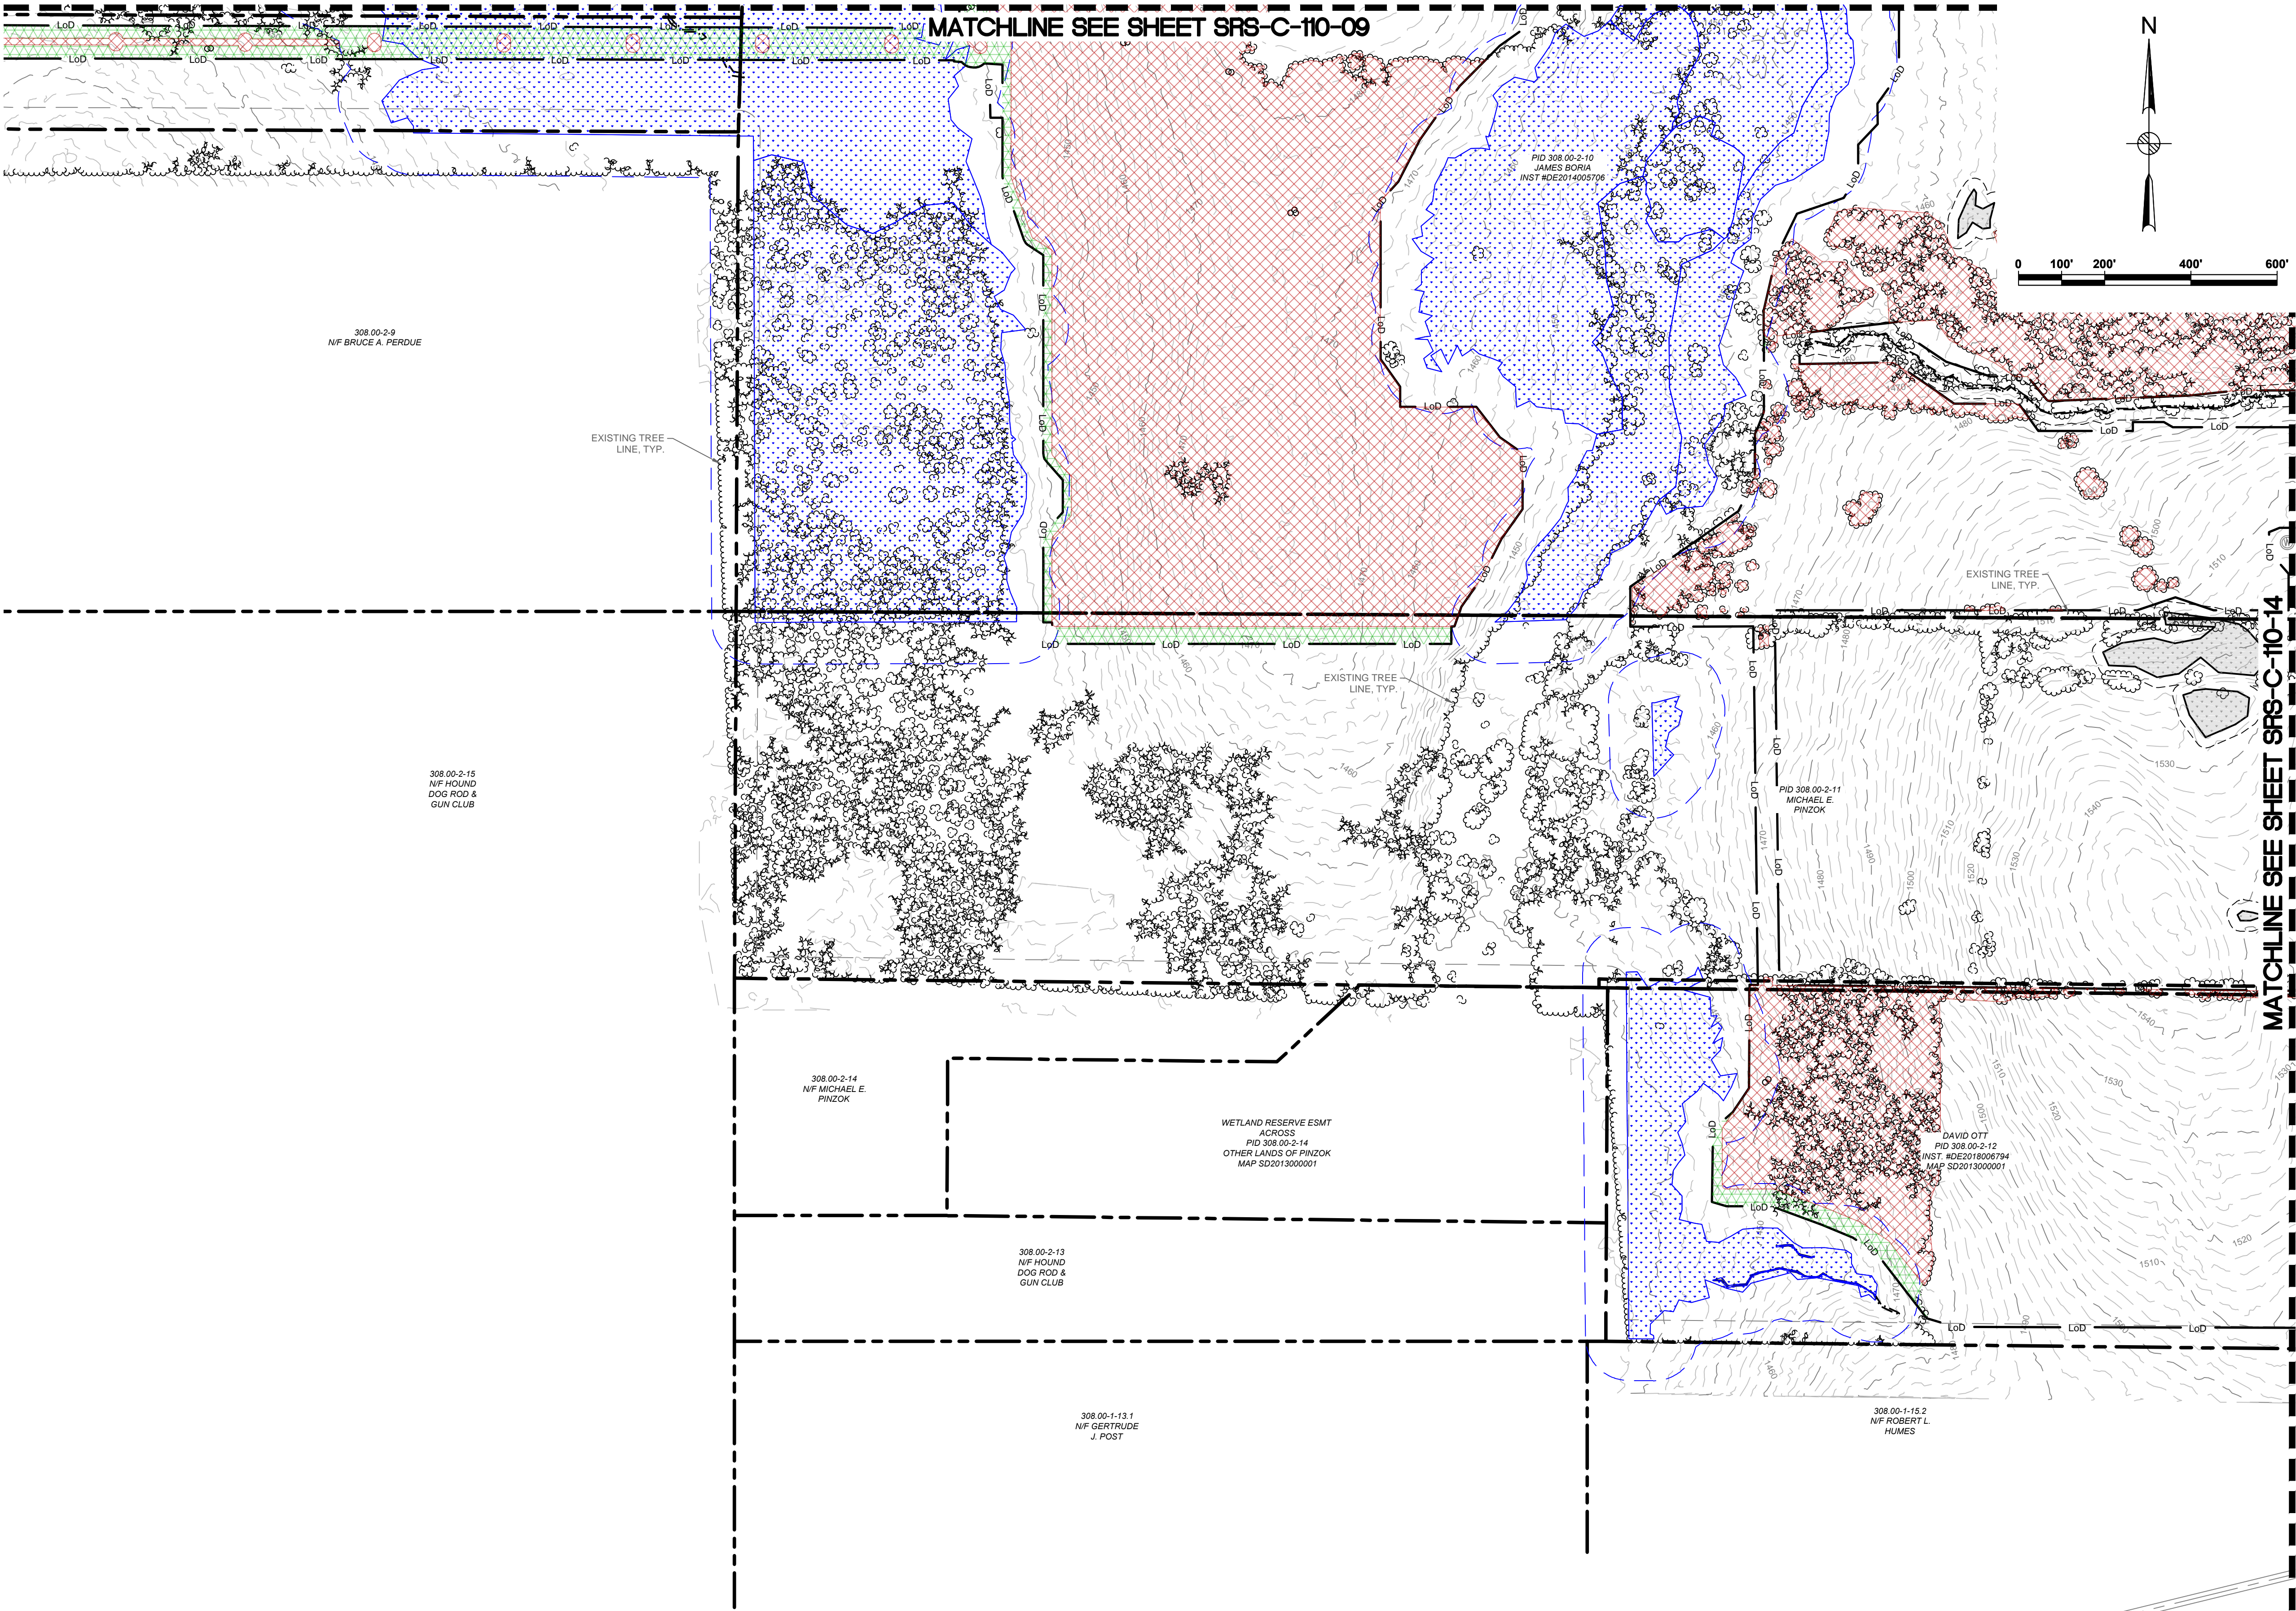	PROPERTY LINES
	PROPERTY LINE SETBACKS
	EXISTING MAJOR CONTOUR
	EXISTING MINOR CONTOUR
	EXISTING TREELINE
	EXISTING GAS LINE & EASEMENT
	GAS WELLS
	WETLANDS - FEDERAL
	WETLANDS - NYSDEC JURISDICTIONAL
	STREAMS - FEDERAL
	STREAMS - NYSDEC JURISDICTIONAL
	FEDERAL WETLANDS/STREAMS - SETBACK
	WETLANDS/STREAMS - SETBACK
	OCCUPIED RESIDENCES
	OCCUPIED RESIDENCE SETBACK
	TREE CLEARING ONLY
	TREE CLEARING & CLEARING/GRUBBING
	LIMITS OF DISTURBANCE
	DRAWING NUMBER
	DRAWING SHEET MATCH LINE



Rev	Date	Drawn	Description	Ch'k'd	App'd
C	07/14/2021	RCB	ISSUED FOR 94C	KW	NJM
B	05/21/2021	RCB	ISSUED FOR REVIEW	KW	NJM
A	01/29/2021	RCB	ISSUED FOR REVIEW	KW	NJM

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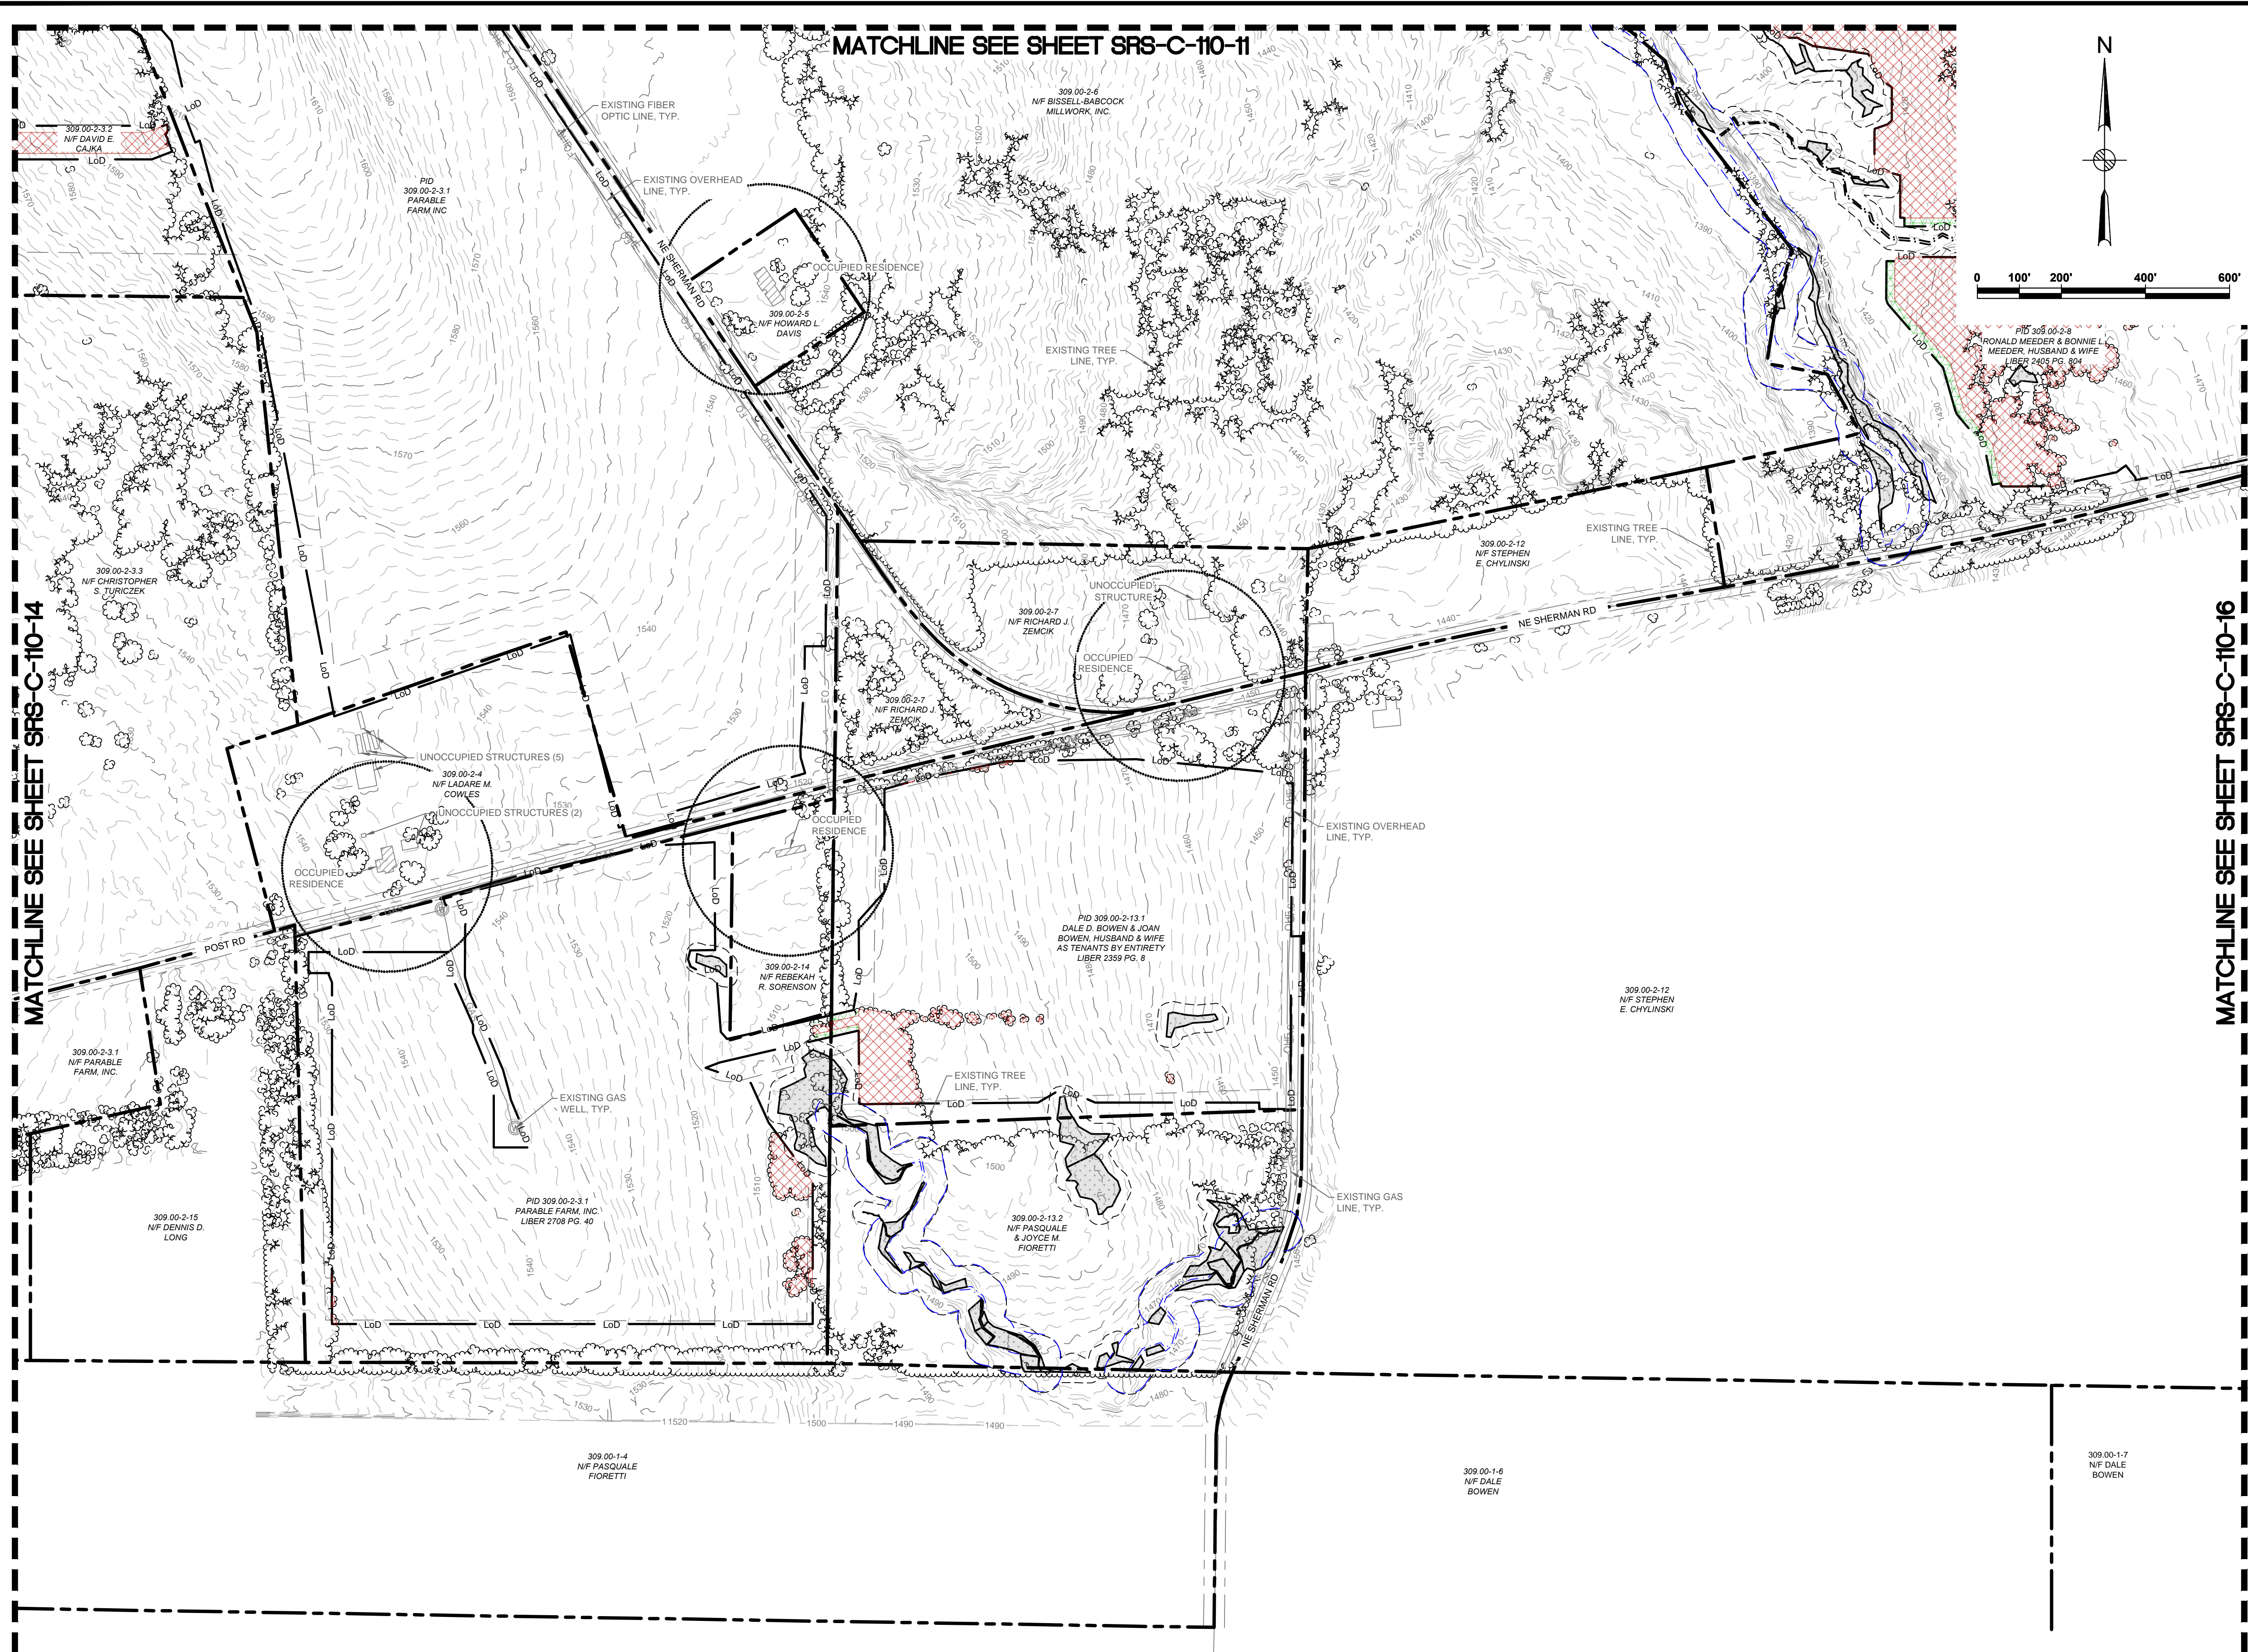
Title

**SOUTH RIPLEY SOLAR
EXISTING CONDITIONS
& CLEARING PLAN
SITE 13**

PRELIMINARY NOT FOR CONSTRUCTION REPLACE WITH ENGINEERS STAMP AT CONSTRUCTION AND/OR FABRICATION	Designed	MU	Eng check	KW
	Drawn	RCB	Approved	NJM
	Dwg check		Project Mngr	
	Scale at ANSI D 1" = 200'	Date	07/14/2021	Rev C
	Drawing Number	SRS-C-110-13		


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Legend

	PROPERTY LINES
	PROPERTY LINE SETBACKS
	EXISTING MAJOR CONTOUR
	EXISTING MINOR CONTOUR
	EXISTING TREELINE
	EXISTING GAS LINE & EASEMENT
	GAS WELLS
	WETLANDS - FEDERAL
	WETLANDS - NYSDEC JURISDICTIONAL
	STREAMS - FEDERAL
	STREAMS - NYSDEC JURISDICTIONAL
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	WETLANDS/STREAMS - SETBACK
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	OCCUPIED RESIDENCE SETBACK
	TREE CLEARING ONLY
	TREE CLEARING & CLEARING/GRUBBING
	LIMITS OF DISTURBANCE
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	DRAWING SHEET MATCH LINE



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South Ripley SOLAR PROJECT


Title

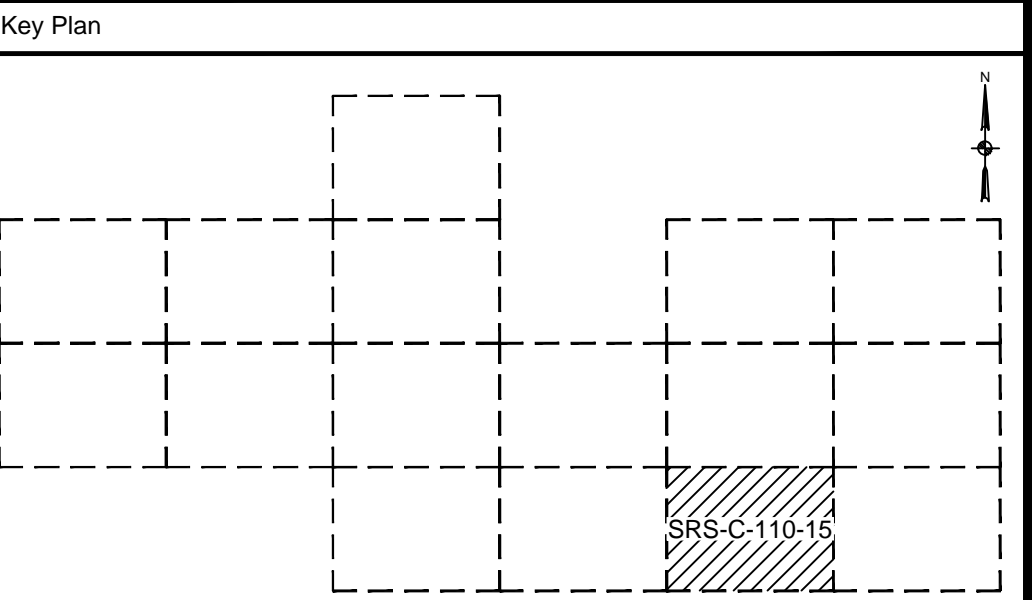**SOUTH RIPLEY SOLAR
EXISTING CONDITIONS
& CLEARING PLAN
SITE 15**


PRELIMINARY NOT FOR CONSTRUCTION REPLACE WITH ENGINEERS STAMP AT CONSTRUCTION AND/OR FABRICATION	Designed	MU	Eng check	KW
	Drawn	RCB	Approved	NJM
	Dwg check	Project Mngr		
	Scale at ANSI D 1" = 200'	Date 07/14/2021	Rev C	
	Drawing Number SRS-C-110-15			

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Legend	
	PROPERTY LINES
	PROPERTY LINE SETBACKS
	EXISTING MAJOR CONTOUR
	EXISTING MINOR CONTOUR
	EXISTING TREELINE
	EXISTING GAS LINE & EASEMENT
	GAS WELLS
	WETLANDS - FEDERAL
	WETLANDS - NYSDEC JURISDICTIONAL
	STREAMS - FEDERAL
	STREAMS - NYSDEC JURISDICTIONAL
	FEDERAL WETLANDS/STREAMS - SETBACK
	WETLANDS/STREAMS - SETBACK
	OCCUPIED RESIDENCES
	OCCUPIED RESIDENCE SETBACK
	TREE CLEARING ONLY
	TREE CLEARING & CLEARING/GRUBBING
	LIMITS OF DISTURBANCE
	DRAWING NUMBER
	DRAWING SHEET MATCH LINE

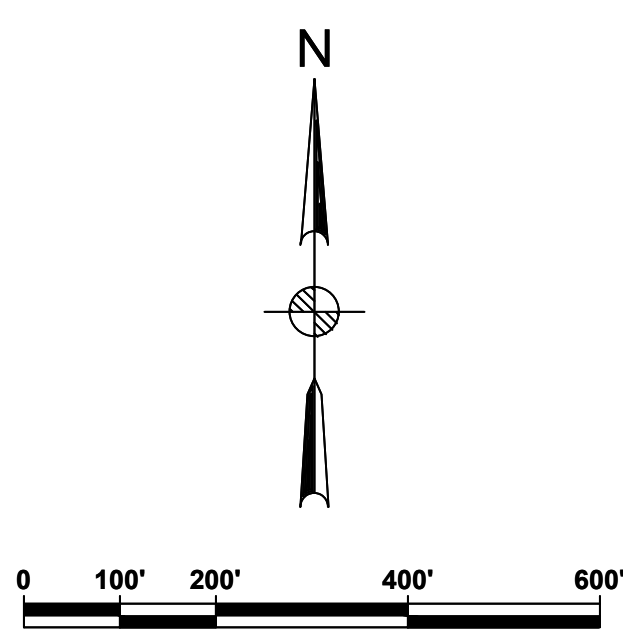

Rev	Date	Drawn	Description	Ch'k'd	App'd
C	07/14/2021	RCB	ISSUED FOR 94C	KW	NJM
B	05/21/2021	RCB	ISSUED FOR REVIEW	KW	NJM
A	01/29/2021	RCB	ISSUED FOR REVIEW	KW	NJM

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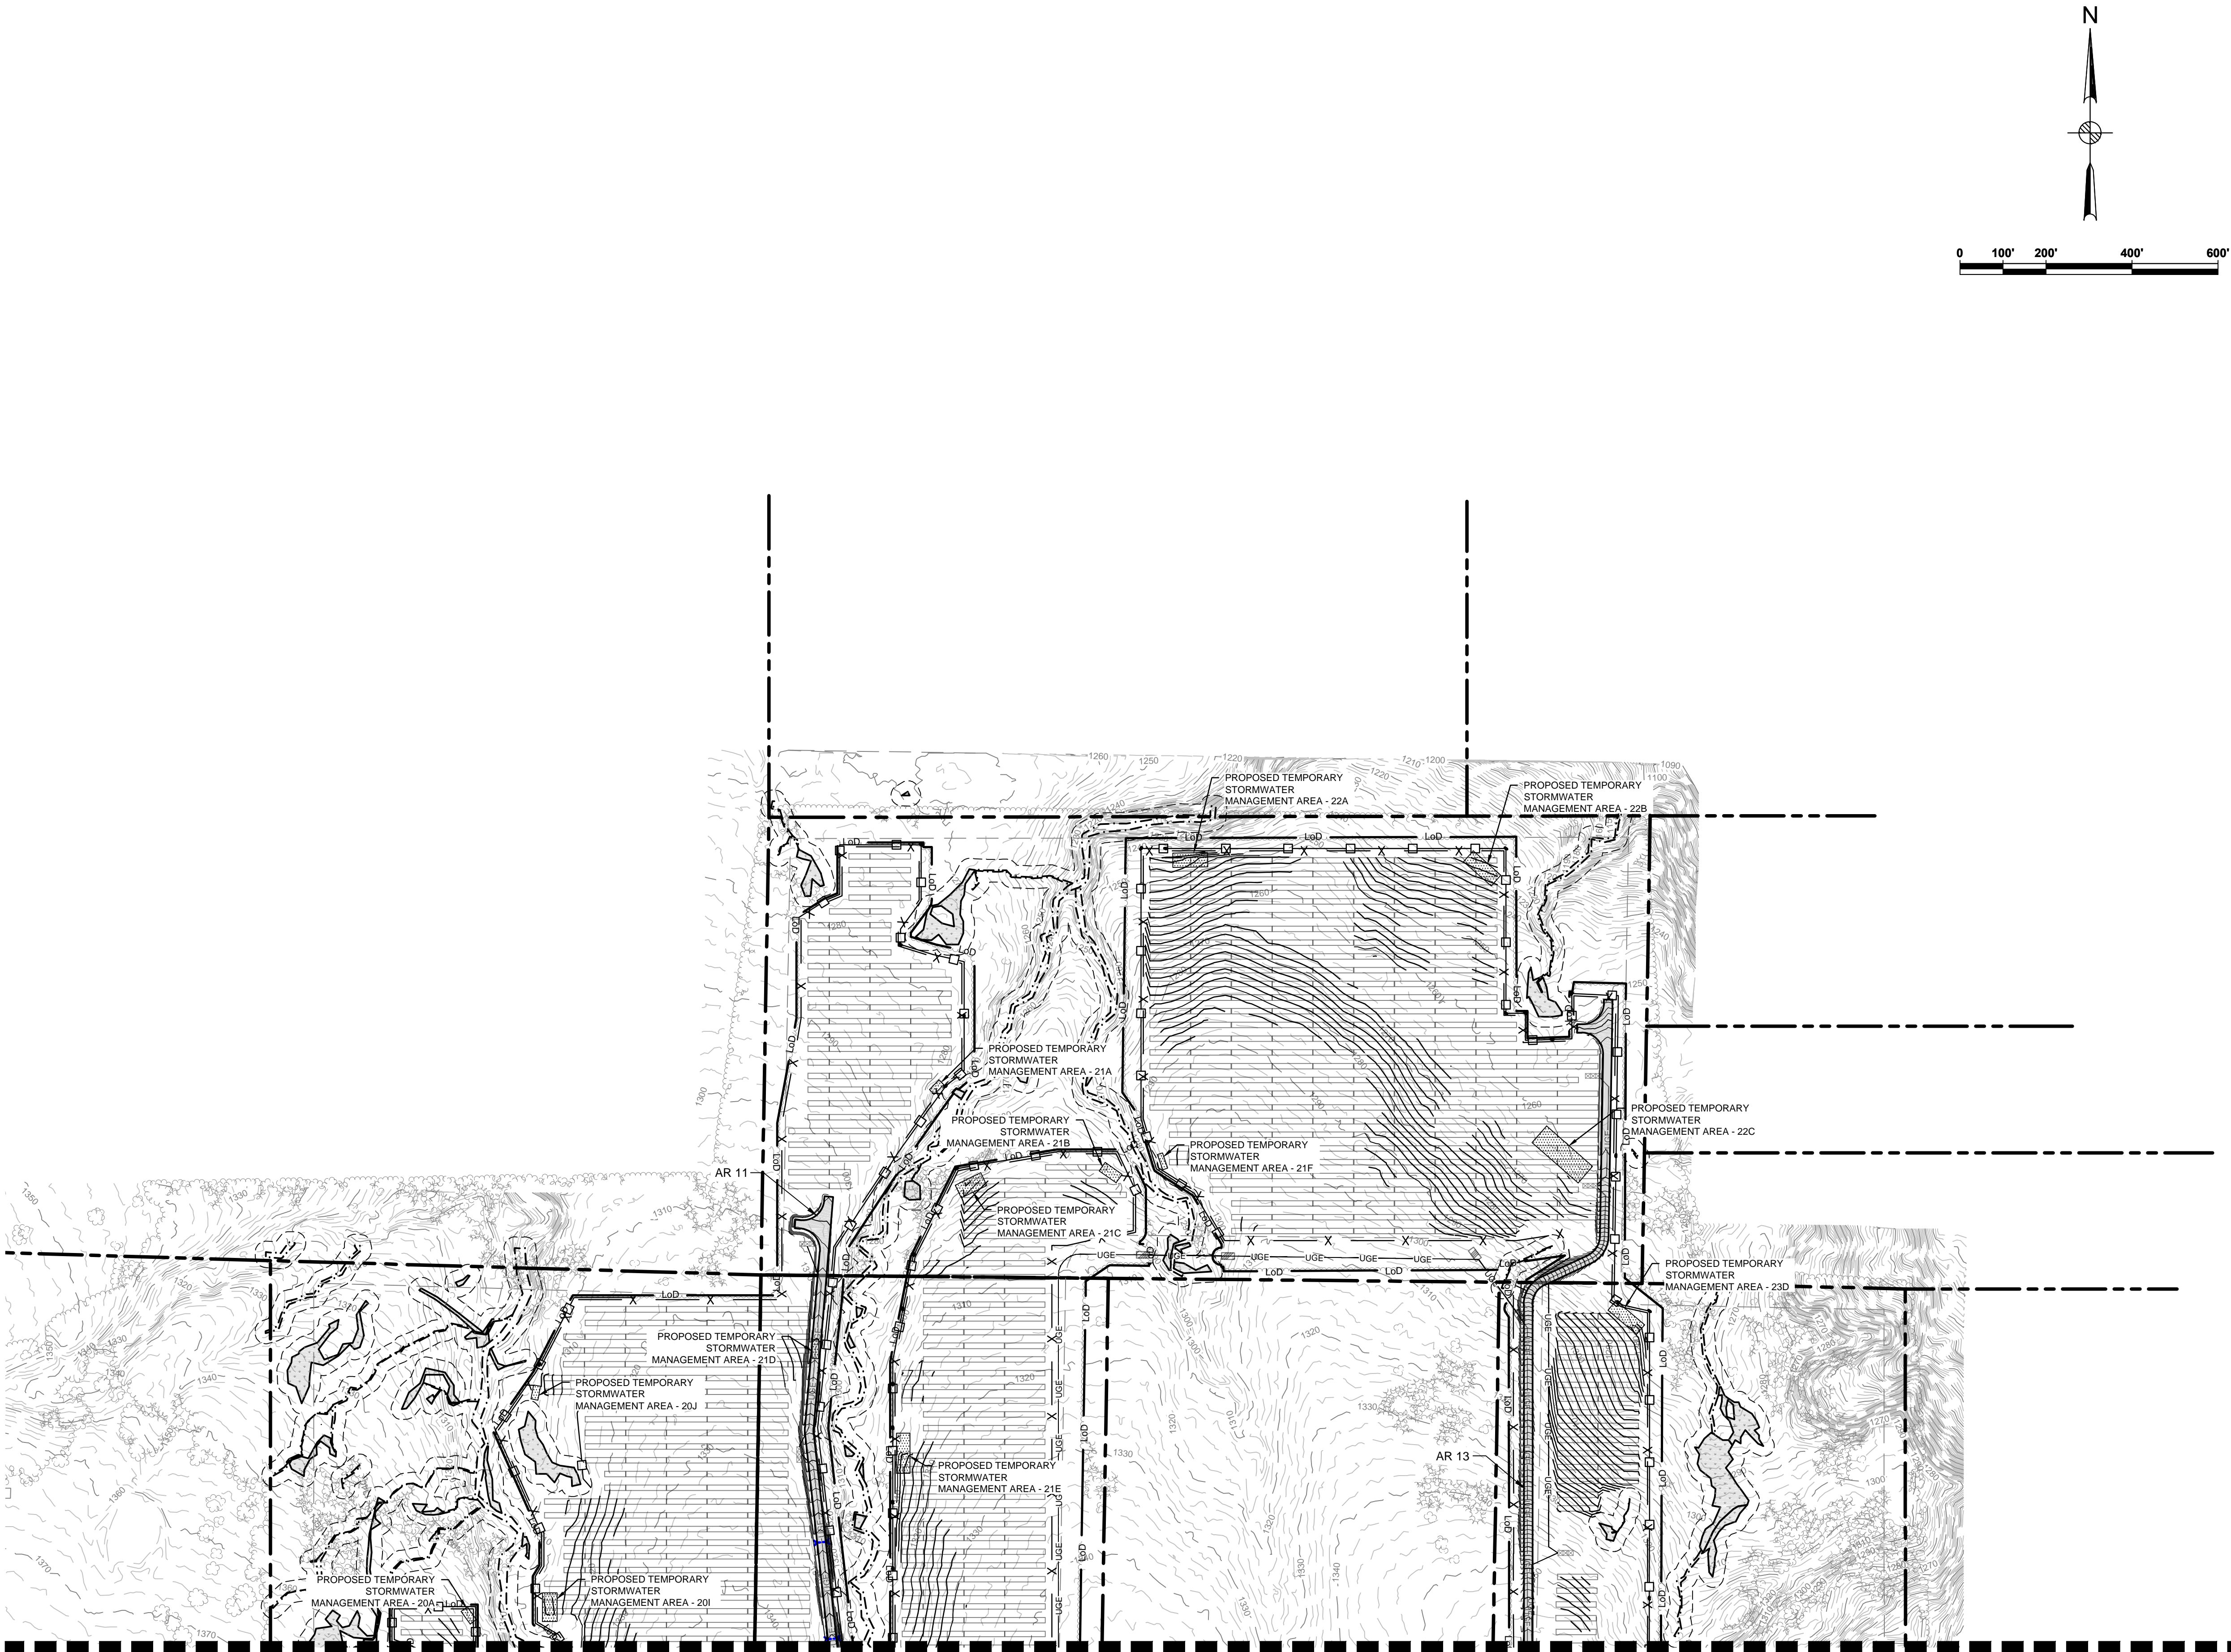
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Title

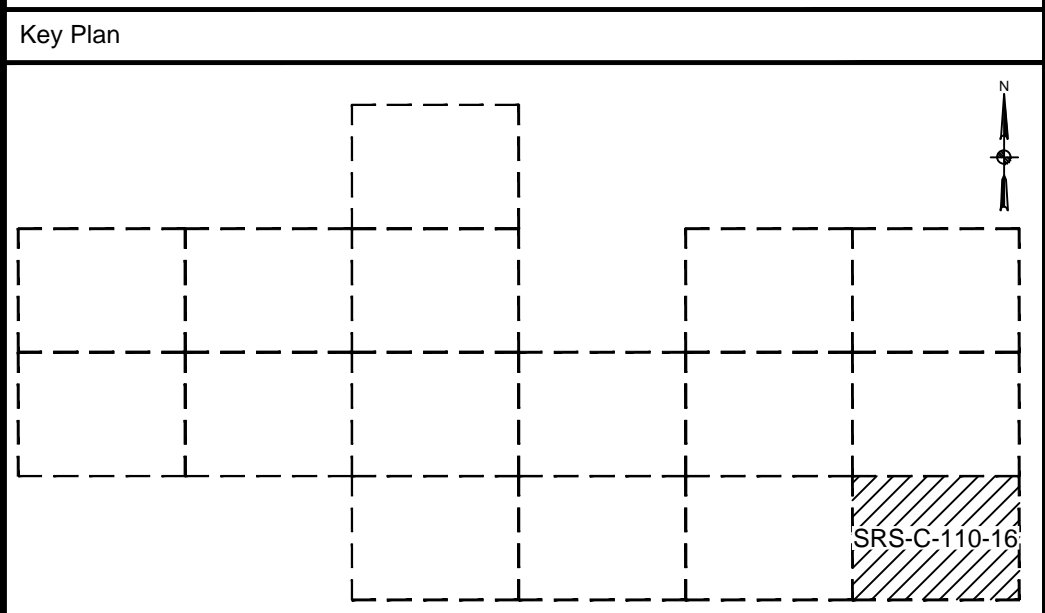SOUTH RIPLEY SOLAR
EXISTING CONDITIONS
& CLEARING PLAN
SITE 16

PRELIMINARY NOT FOR CONSTRUCTION REPLACE WITH ENGINEERS STAMP AT CONSTRUCTION AND/OR FABRICATION	Designed	MU	Eng check	KW
	Drawn	RCB	Approved	NJM
	Dwg check		Project Mngr	
	Scale at ANSI D 1" = 200'	Date	07/14/2021	Rev C
	Drawing Number	SRS-C-110-16		

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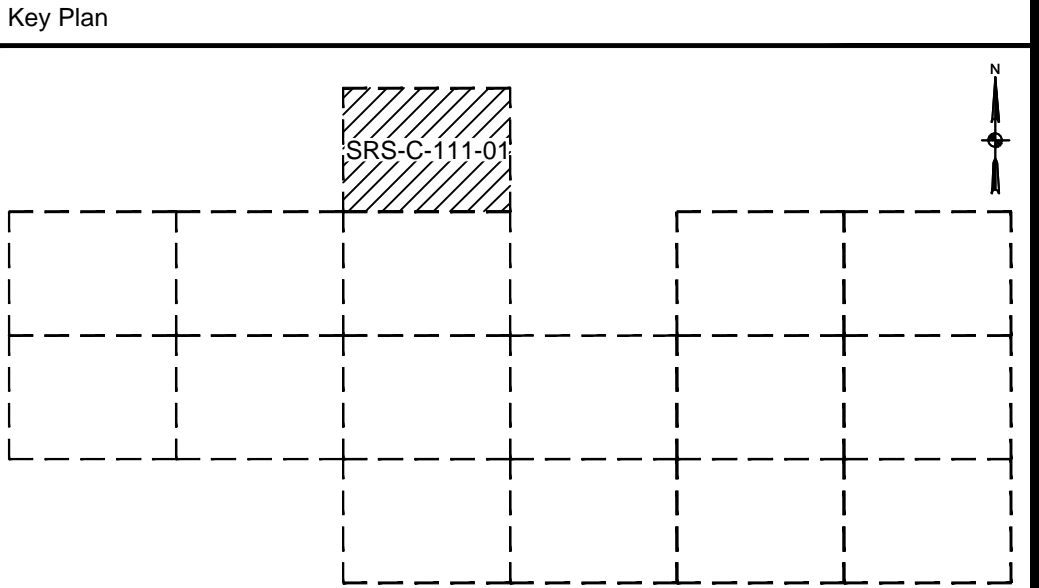


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MATCHLINE SHEET C-111-04

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Legend	
	PROPERTY LINES
	PROPERTY LINE SETBACKS
	PROPOSED PERIMETER FENCE
	PROPOSED MAJOR CONTOUR
	PROPOSED MINOR CONTOUR
	PROPOSED OVERHEAD LINE
	PROPOSED UNDERGROUND LINE
	PROPOSED ACCESS ROAD
	WETLANDS - FEDERAL
	WETLANDS - NYSDEC JURISDICTIONAL
	STREAMS - FEDERAL
	STREAMS - NYSDEC JURISDICTIONAL
	FEDERAL WETLANDS/STREAMS - SETBACK
	WETLANDS/STREAMS - SETBACK
	SOLAR MODULES
	PROPOSED LANDSCAPE AREAS
	EXISTING VEGETATIVE BUFFER
	PROPOSED FOR SCREENING
	OCCUPIED RESIDENCES
	OCCUPIED RESIDENCE SETBACK
	EXISTING MAJOR CONTOUR
	EXISTING MINOR CONTOUR
	EXISTING GAS LINE & EASEMENT
	SILT FENCE
	LIMITS OF DISTURBANCE
	STORM/PIPE CULVERT
	PROPOSED INVERTER PAD LOCATIONS (SEE ELECTRICAL)
	PROPOSED JUNCTION BOX LOCATIONS (SEE ELECTRICAL)
	ROCK FILTER OUTLET
	GAS WELLS
	BORE PITS
	DRAWING NUMBER
	DRAWING SHEET MATCH LINE



Rev	Date	Drawn	Description	Ch'k'd	App'd
C	07/14/2021	JSD	ISSUED FOR 94C	KW	NJM
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South Ripley
SOLAR PROJECT

Title

**SOUTH RIPLEY SOLAR
GRADING AND EROSION CONTROL
SITE 1**

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	Drawn	RCB	Approved	NJM
	Dwg check		Project Mngr	
	Scale at ANSI D 1" = 200'	Date	Rev	C
	Drawing Number	SRS-C-111-01		